

HARPER PERKINS ARCHITECTS, INC.

4724 Old Jacksboro Highway
Telephone 940.767.1421

Wichita Falls, Texas 76302-3599
Facsimile Number 940.397.0273

ADDENDUM NO. 2

To the Drawings and Project Manual dated 25 February 2021
for

**J.S. BRIDWELL HALL
NEW KINESIOLOGY LAB
MIDWESTERN STATE
UNIVERSITY**
3410 Taft Boulevard
Wichita Falls, Texas



Addendum Date: 15 March 2021

NOTICE TO PROPOSERS:

This Addendum will be considered a part of the Contract Documents for the above referenced project as though it had been issued at the same time and incorporated integrally therewith. Where provisions of the following supplementary data differ from those in the original Contract Documents, this Addendum shall govern and take precedence.

Proposers are hereby notified that they shall make any necessary adjustments in their estimates on account of this Addendum. It will be construed that such Proposer's Competitive Sealed Proposal is submitted with full knowledge of all modifications and supplementary data specified herein.

ITEM 1 - AD#2: To the Project Manual and Drawings.

ADD: A Pre-Bid Meeting was held on Thursday, March 11 at 2:00 p.m. An electronic copy of the Sign-In Sheet for the Meeting is available at www.msutexas.edu/purchasing.

ADD: If a General Contractor, Sub-Contractor, Materials Supplier, etc. would like to visit the Building/Site for additional field verification and observation, please make arrangements with Dave Percy, MSU Texas Director of Construction Services. His cell phone number is (940) 232-7288.

ITEM 2 - AD#2: To the Project Manual, Section **00200, INSTRUCTIONS TO PROPOSERS.**

DELETE: On page **00200-3** at the end of the Section, the indication of the Project being completed by July 1, 2021.

ADD: As clarification, each Proposer shall include in the Bid their completion date for the Base Bid AND each Alternate. The Base Bid shall be completed by September 1, 2021. Requests for extension of time due to delays in materials delivery, etc. will be handled on a case-by-case basis.

ITEM 3 - AD#2: To the Project Manual, Section **096420, WOOD GYMNASIUM FLOORING.**

ADD: On page **096420-3**, under "**1.3 QUALITY ASSURANCE**" under "**Part 1.3 MANUFACTURER**", an acceptable alternate manufacturer of Wood Gymnasium Flooring Systems is **Tarkett Sports** (Rep. – Flavia Cerreto of Zoche LLC located in Burleson, Texas; phone: 817-246-2223). This acceptable alternate manufacturer shall be responsible for meeting or exceeding all final requirements; material quality; product construction, details

and configurations; installation methods; specifications; and warranties related to the specified *Connor Sports* products/systems. This includes, but is not limited to, such items as the maple thickness, wood flooring grade, type of cushion pads, vapor barrier thickness, subfloor material and thickness, warranty period, etc.. Once Bids are received, the Architect & proposed General Contractor shall evaluate any submitted products/systems other than those specified as per Section **012500, SUBSTITUTION PROCEDURES**, and then make a determination/recommendation in consultation with the Owner as to its use on this project.

ITEM 4 - AD#2: To the Structural Drawings.

ADD: As clarification, portions of the structural and architectural drawings included the original Construction Documents for the existing Building are included on Sheets “**AD#1-01**” through “**AD#1-08**” attached to this Addendum. The drawings are included for informational purposes only to aid in determining dimensions for new structural elements associated with the new Basketball Goal. The successful Bidder shall field verify existing conditions immediately at the commencement of work and notify the Architect & Owner of any differences to the original drawings.

ADD: As clarification on Sheet “**S301**”, details “**03/S301**” and “**04/S301**” are general details and are not necessarily details for this specific Project.

ADD: As clarification on Sheet “**S301**”, details “**01/S301**” and “**02/S301**”, the details for the grade beams/stem walls shall apply for the greatest heights that will occur in association with the placement of the new concrete slab, generally the east and south sides of the space. This includes the detailing associated with the reinforcing and dowels.

ITEM 5 - AD#2: To the Project Manual and Drawings.

ADD: The Proposer shall coordinate with the Owner on “portable” items (i.e. Speakers, etc.) that are to be removed as part of the demolition work. The Owner may wish to retain the item(s) or have it moved to an area for further processing by the University.

ITEM 6 - AD#2: To the Electrical Drawings.

ADD: As clarification, existing Data Drops that were installed as part of a previously completed project shall be maintained in this project. This includes raising the drop to be above the new concrete slab or extended to the face of new wall covering (i.e. new plywood or gypsum board layer).

ADD: As clarification, the boxes and conduit for data outlets shall be provided and installed in this Contract. Data devices and cabling will be provided by the Owner. Coordinate all data-related work with the Owner’s Installers.

DELETE: On Sheet “**E101**”, under “**GENERAL NOTES**”, the wording for note “**P**”.

ADD: the wording for General Note “**P**” shall read as follows: “IN KINESIOLOGY LAB, ALL NEW & EXISTING ELECTRICAL, CONTROL, AND COMMUNICATION WIRING SHALL BE IN CONDUIT. CONDUIT SHALL BE ROUTED IN OR ALONG TOP OF WALLS. WHERE REQUIRED, CONDUIT SHALL BE ROUTED ALONG STRUCTURAL MEMBERS TO PROVIDE PROTECTION FROM BALL STRIKES (CONDUIT SHALL NOT SPAN OPEN SPACE)”.

ADD: As clarification, all existing electrical outlets and switches that are to remain, shall be extended to the new facing (i.e. plywood, gypsum board, etc.) of walls through the use of extension rings, etc.

ITEM 7 - AD#2: To the Project Manual and Drawings.

ADD: The Owner will provide a space for use by the Proposer as a Field Office. The exact location of this space will be coordinated with the Owner upon the award and execution of the Contract.

ADD: The Owner will provide a “lay-down area” for materials that is generally on either the north or south side of the Building. The exact location of this area will be coordinated with the Owner upon the award and execution of the Contract.

ITEM 8 - AD#2: To the Drawings, Sheet “**A101**”, “**Floor Plan - New**” and “**Floor Plan Keynotes**”.


ADD: As clarification under Keynote **#7**, the existing walls (currently gypsum board with vinyl wall covering to remain) will receive a new layer of ½” plywood up to 8’-0” A.F.F. From that point, a new layer of ½” gypsum board shall be provided over the existing gypsum board. At the location in which there is no gypsum board and only existing exposed structural steel studs in exterior walls occur (generally starting at the existing suspended ceiling lines), provide two (2) layers of gypsum board (one 5/8” thick and one ½” thick) over the studs. Provide the batt insulation in the wall cavity as indicated in the note. Also, provide the “High-Impact Resistant” gypsum board on the southeast wall behind the Basketball Goal as indicated in the note. At locations along the southeast and northeast wall areas in which furred-out walls occur in “front of” the exterior walls, gypsum board layers will not occur on the exterior studs, however the batt insulation shall still be installed. The furred out walls shall receive

extensions – see below.

ADD: To Keynote **#7**, the existing furred-out walls along the northeast and southeast sides shall receive extensions from the top of the walls (generally just above the existing suspended ceiling lines) to the existing roof deck/structure. The extensions shall be composed of 3 5/8" metal studs @ 16" o.c. – provide continuous metal stud runners at the top & bottom of the walls. Provide with metal stud bracing @ 32" o.c. horizontal between these wall extensions and the existing exterior wall studs. Cover the wall extensions with two (2) layers of gypsum board (one 5/8" thick and one 1/2" thick), tape & bed and finish as scheduled.

ADD: As clarification under Keynote **#12**, the approximate size of the "Projection Screen Surface" on the northeast wall shall be approximately 6'-0"H. x 12'-0"L. Provide 1x4 continuous popular wood trim around the perimeter of the "Projection Screen Surface" – caulk & fill trim joints and nail holes & paint. The exact location of the Screen in the horizontal plane of the wall shall be as per the note, coordinated with the Architect & Owner.


END OF ADDENDUM NO. 2

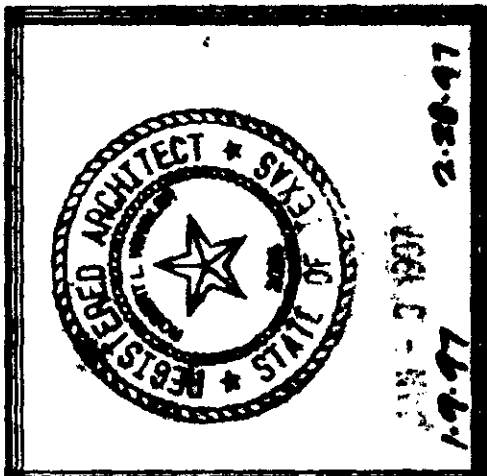


J.S. BRIDWELL HALL
MIDWESTERN STATE UNIVERSITY
WICHITA FALLS, TEXAS

WINGLER & SHARP
ARCHITECTS & PLANNERS, INC.
SECOND FLOOR
FRAMING PLAN


JANUARY 8, 1997

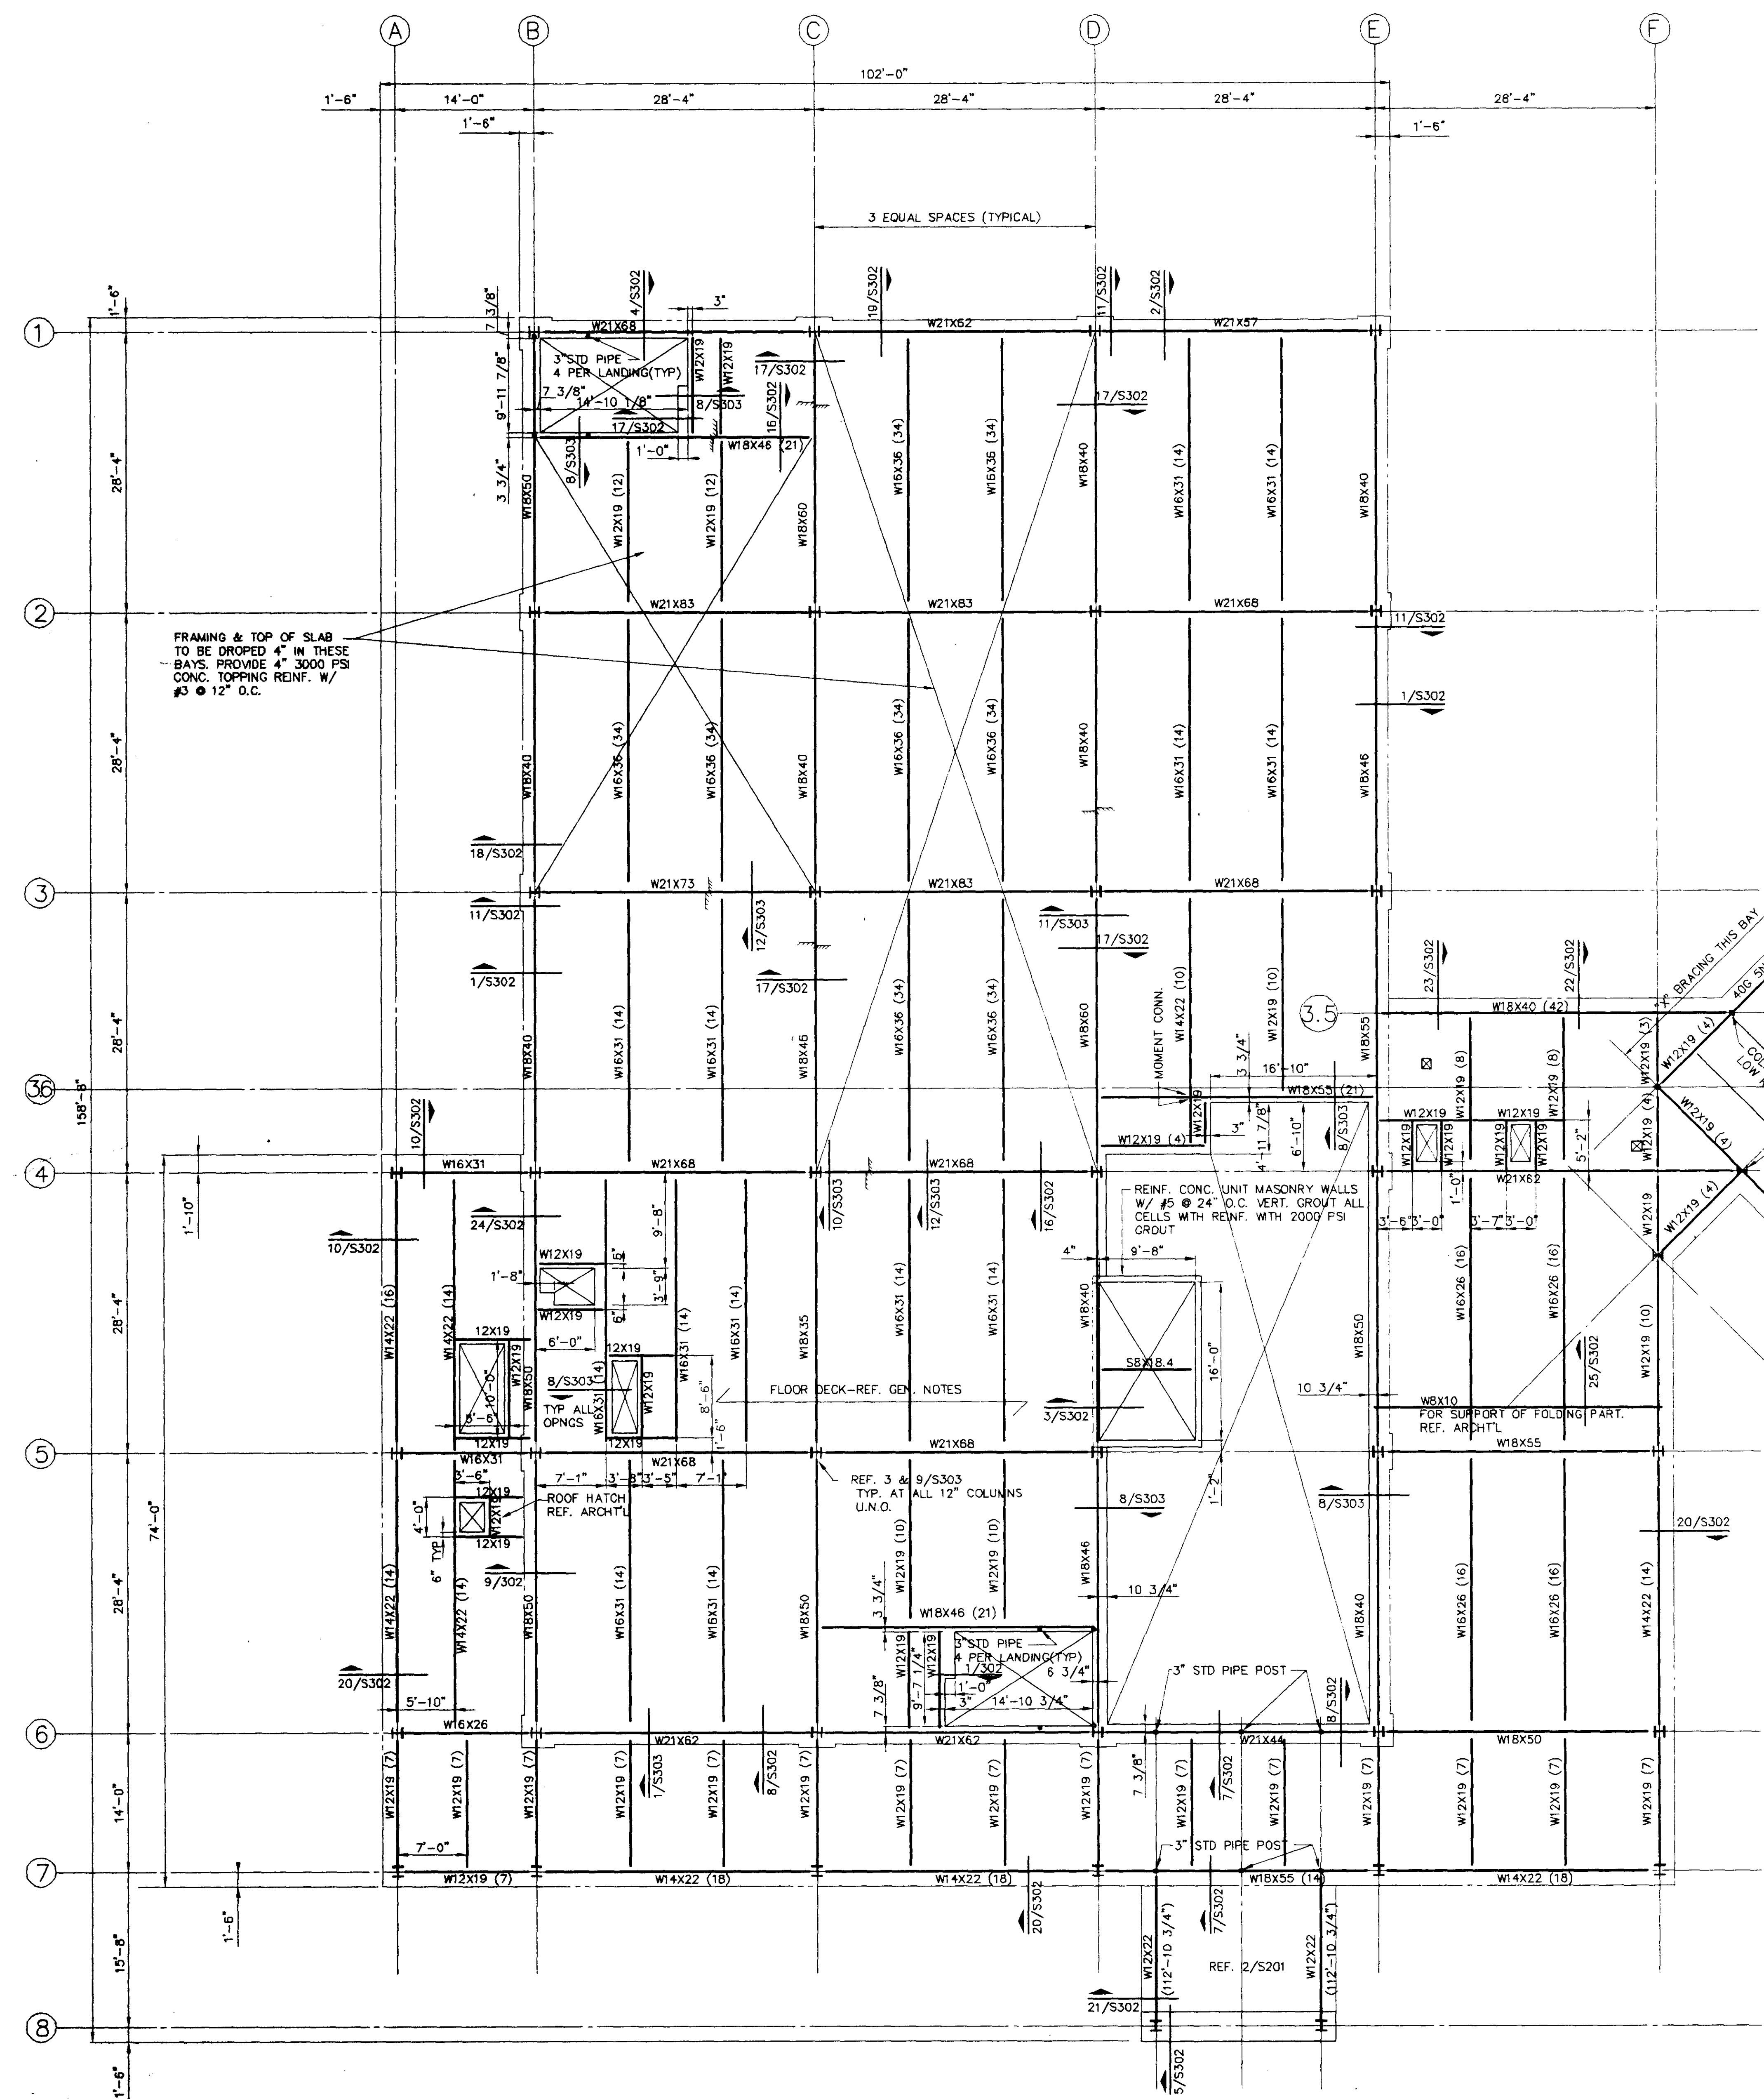



2 CANOPY ROOF FRAMING PLAN

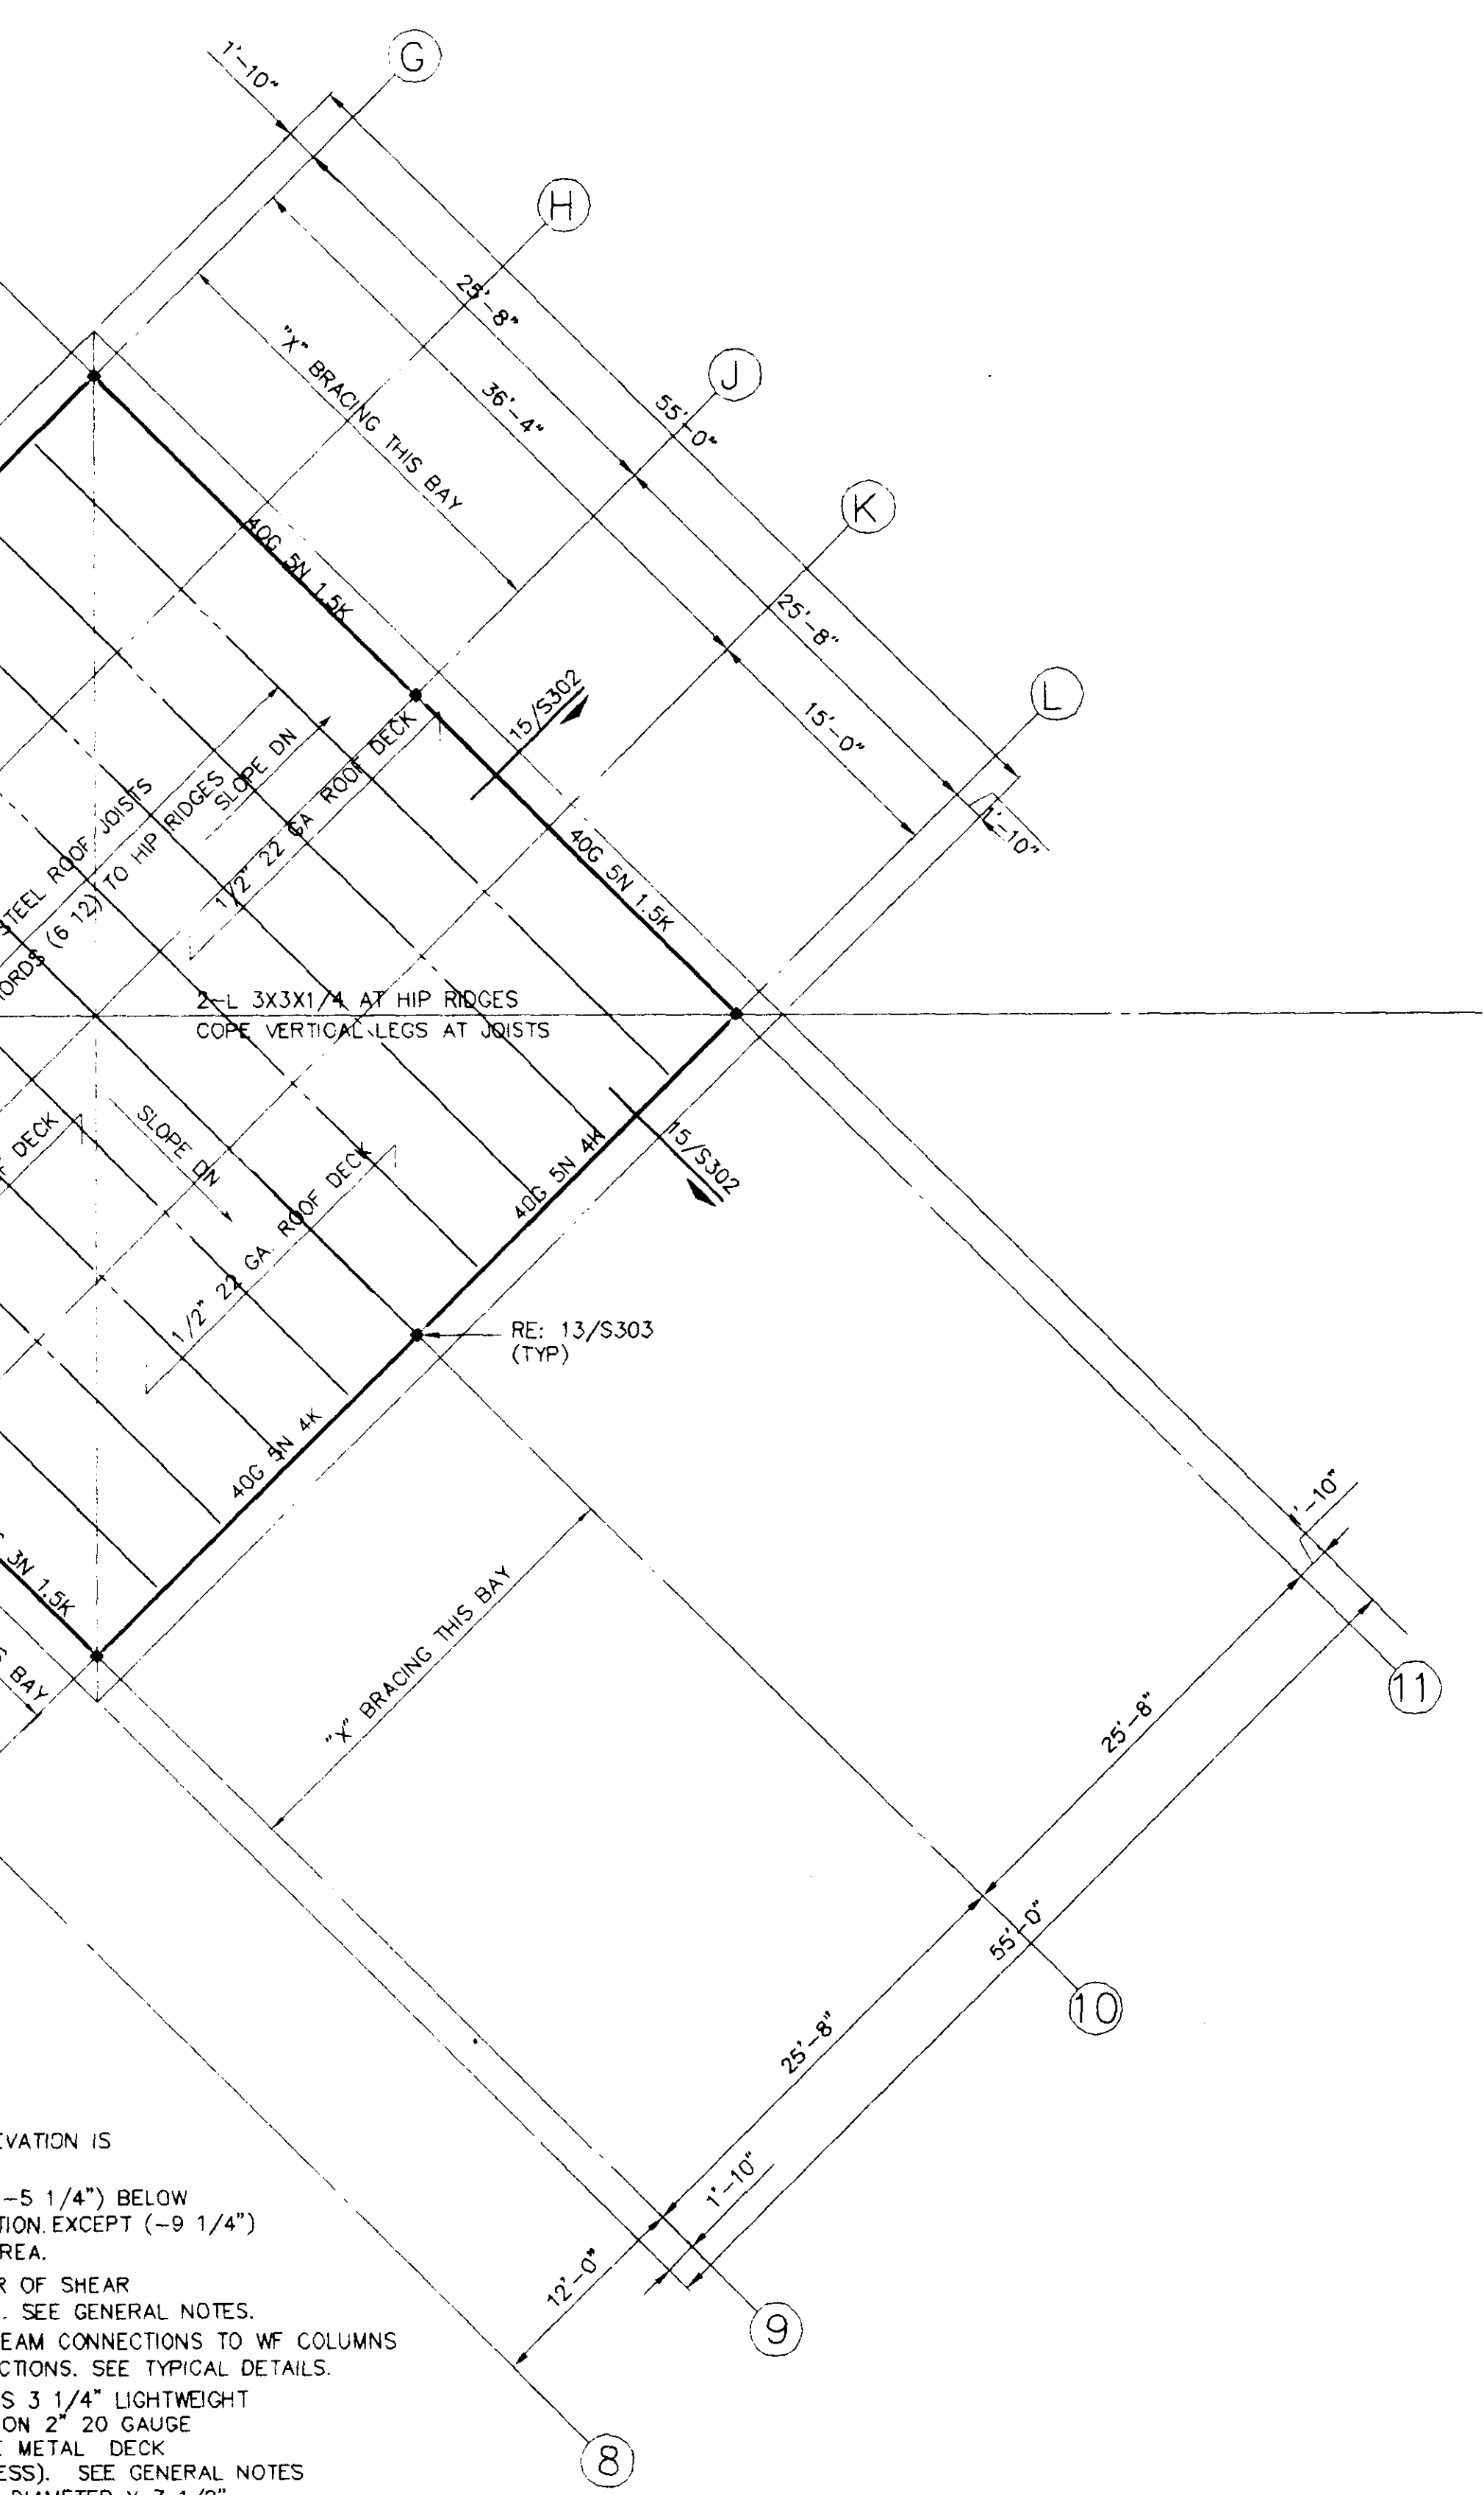

- PLAN NOTES:
1. TOP OF ROOF SLAB ELEVATION IS +113'-4", U.N.O.
 2. TOP OF STEEL BEAMS (-5 1/4") BELOW FINISHED FLOOR ELEVATION EXCEPT (-9 1/4") AT DEPRESSED SLAB AREA.
 3. (24) INDICATES NUMBER OF SHEAR CONNECTORS REQUIRED. SEE GENERAL NOTES.
 4. ALL NON-COMPOSITE BEAM CONNECTIONS TO WF COLUMNS TO BE MOMENT CONNECTIONS. SEE TYPICAL DETAILS.
 5. FLOOR CONSTRUCTION IS 3 1/4" LIGHTWEIGHT CONCRETE, ROOF SLAB ON 2" 20 GAUGE GALVANIZED COMPOSITE METAL DECK (5 1/4" TOTAL THICKNESS). SEE GENERAL NOTES & DETAILS. USE 3/4" DIAMETER X 3 1/2" HEADED STUD SHEAR CONNECTORS, UNLESS NOTED OTHERWISE.
 6. DESIGN TOP CHORD OF ALL JOISTS GIRDERS FOR AN ADDITIONAL AXIAL WIND LOAD OF 17 KIPS.
 7. VERIFY LOCATIONS & DIMENSIONS OF FLOOR & ROOF OPENING WITH MECHANICAL & ARCHITECTURAL DRAWINGS.

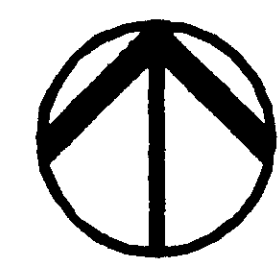

1 SECOND FLOOR FRAMING PLAN

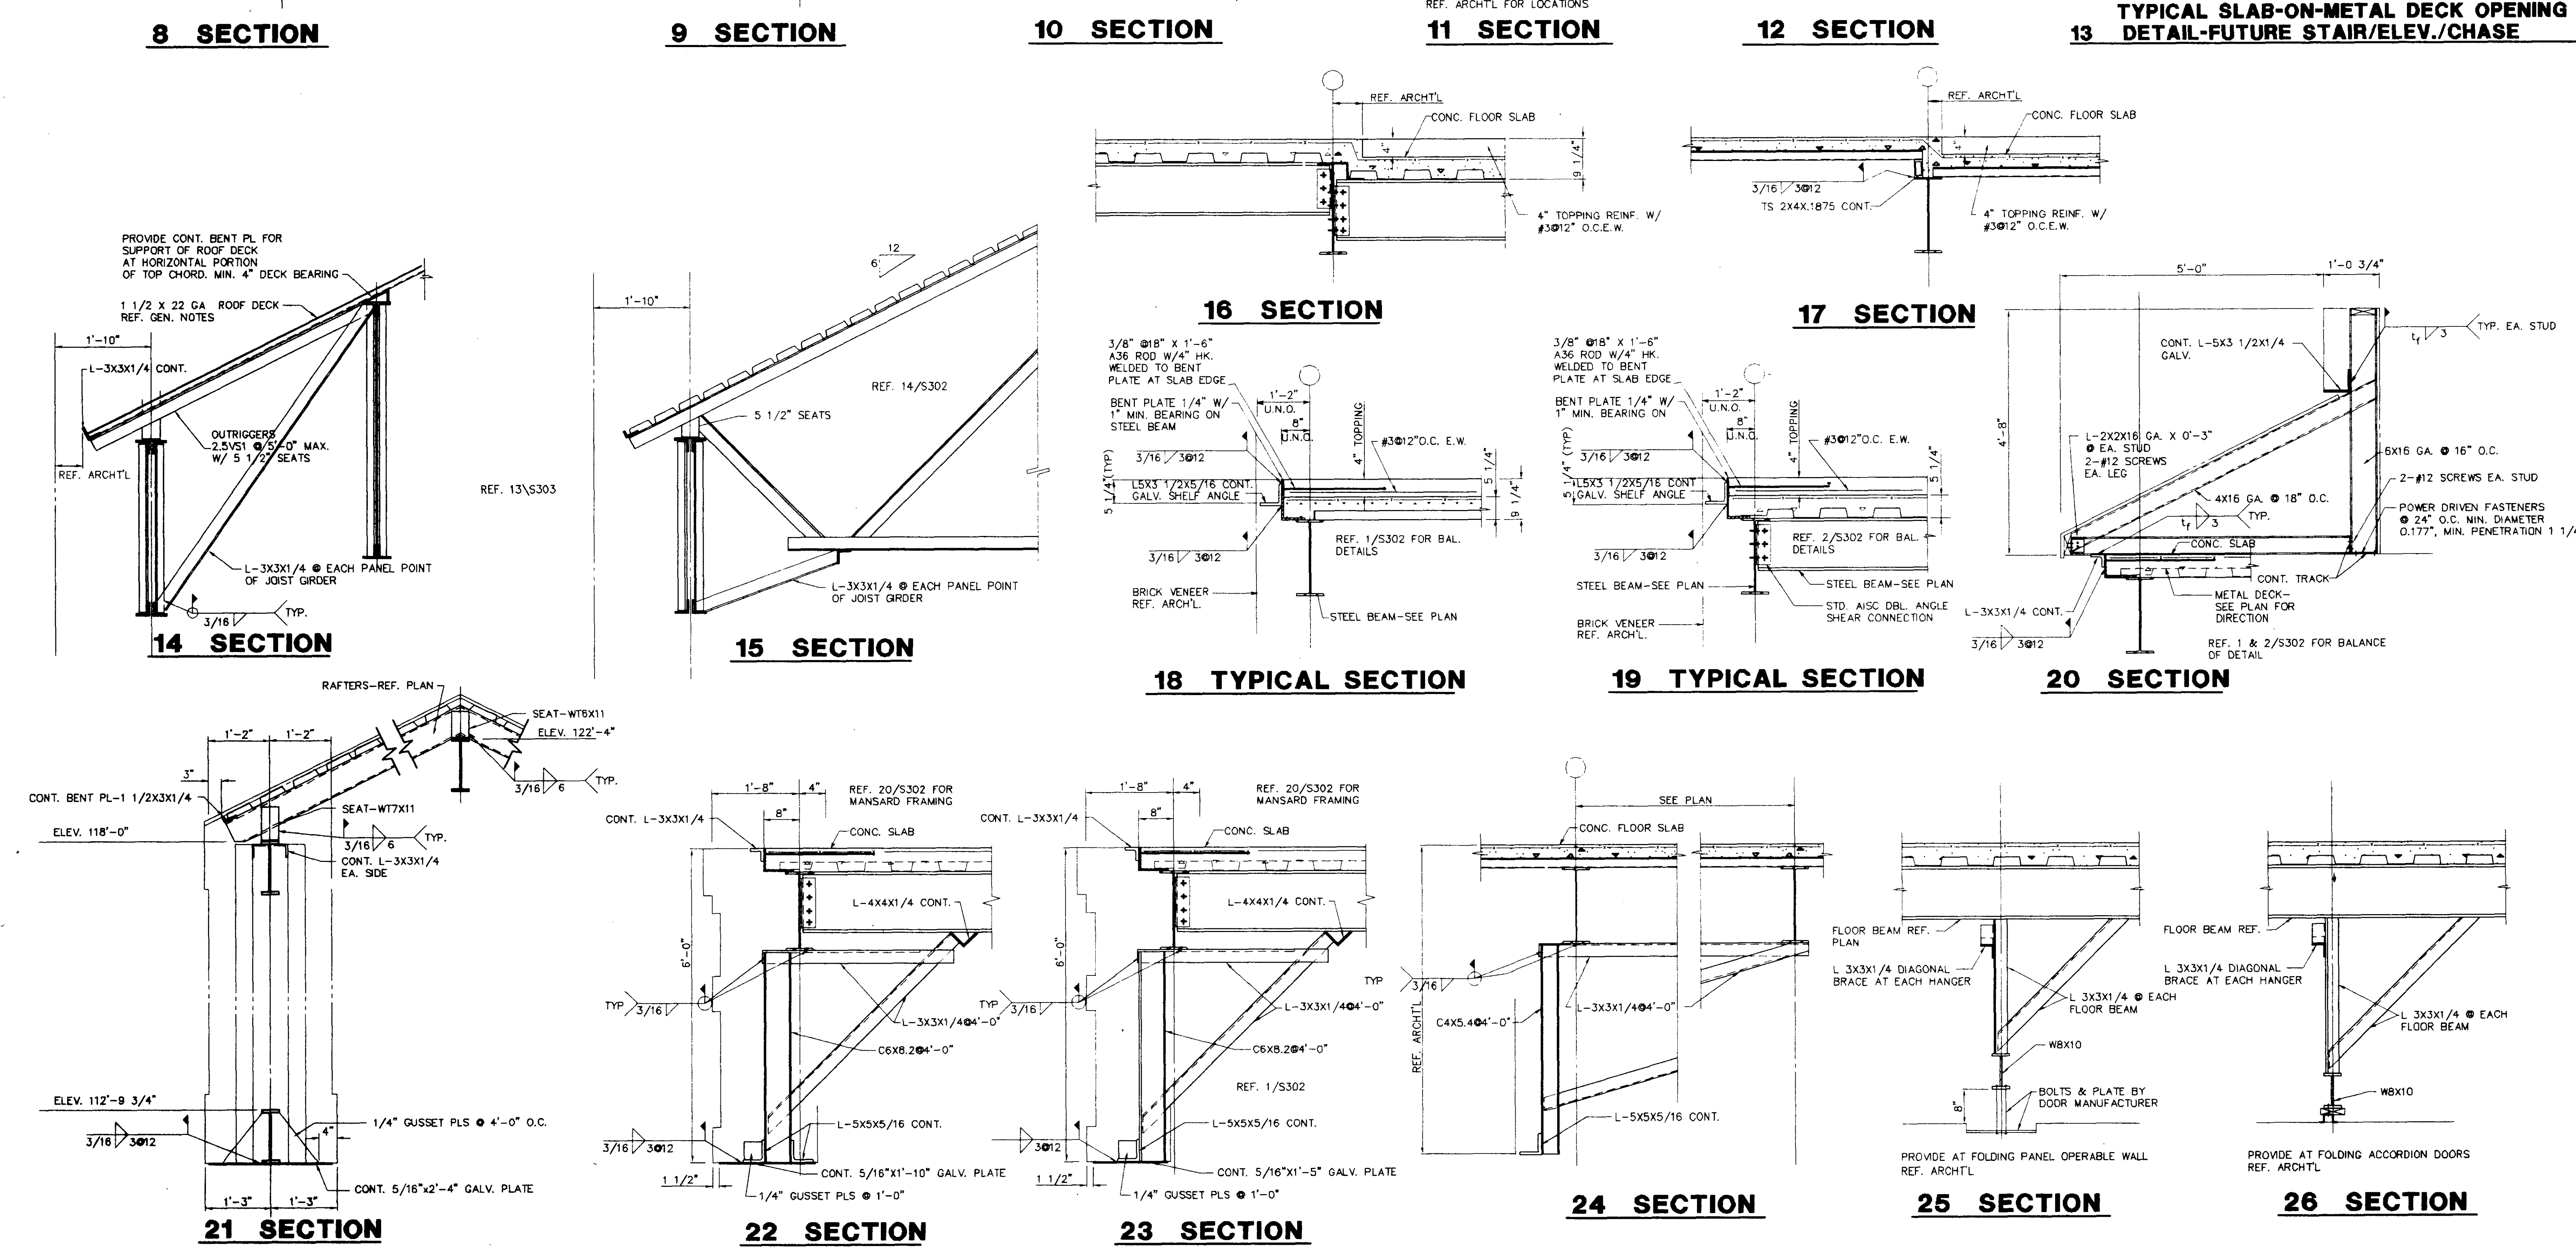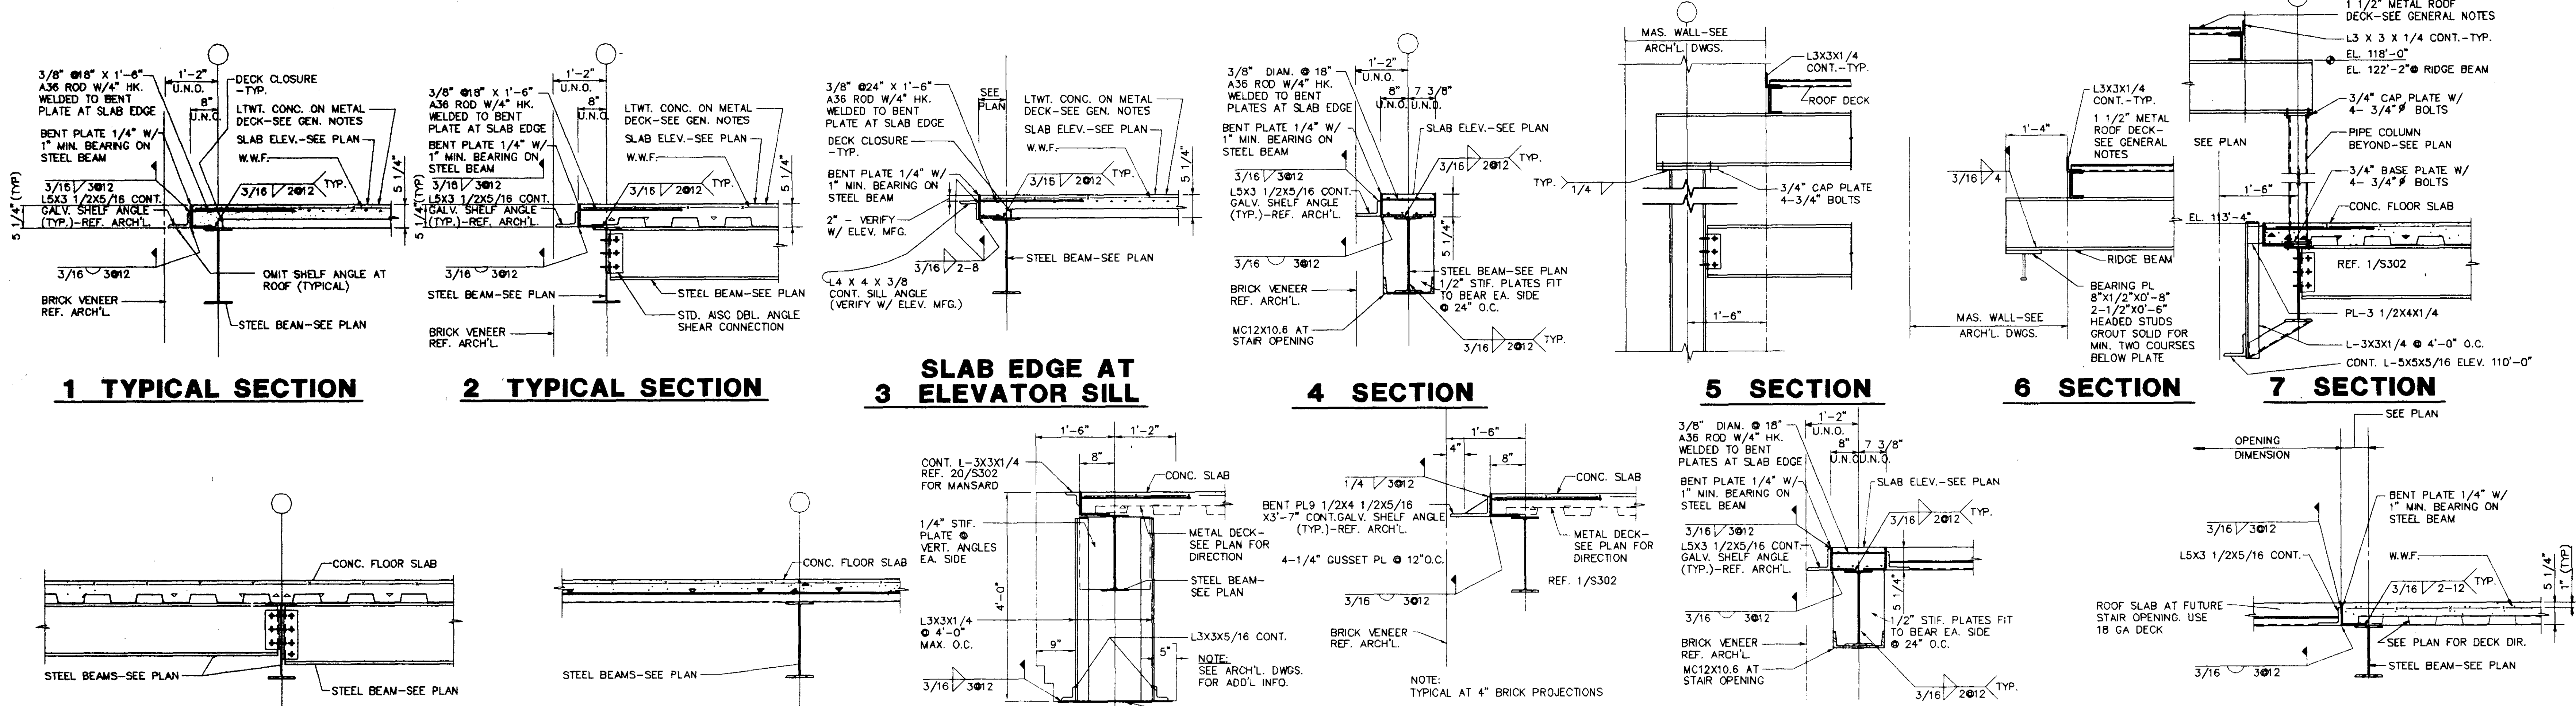




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WICHITA FALLS, TEXAS

WINBLER & SHARP
ARCHITECTS & PLANNERS, INC.




SECTIONS AND DETAILS

JANUARY 8, 1997




9302

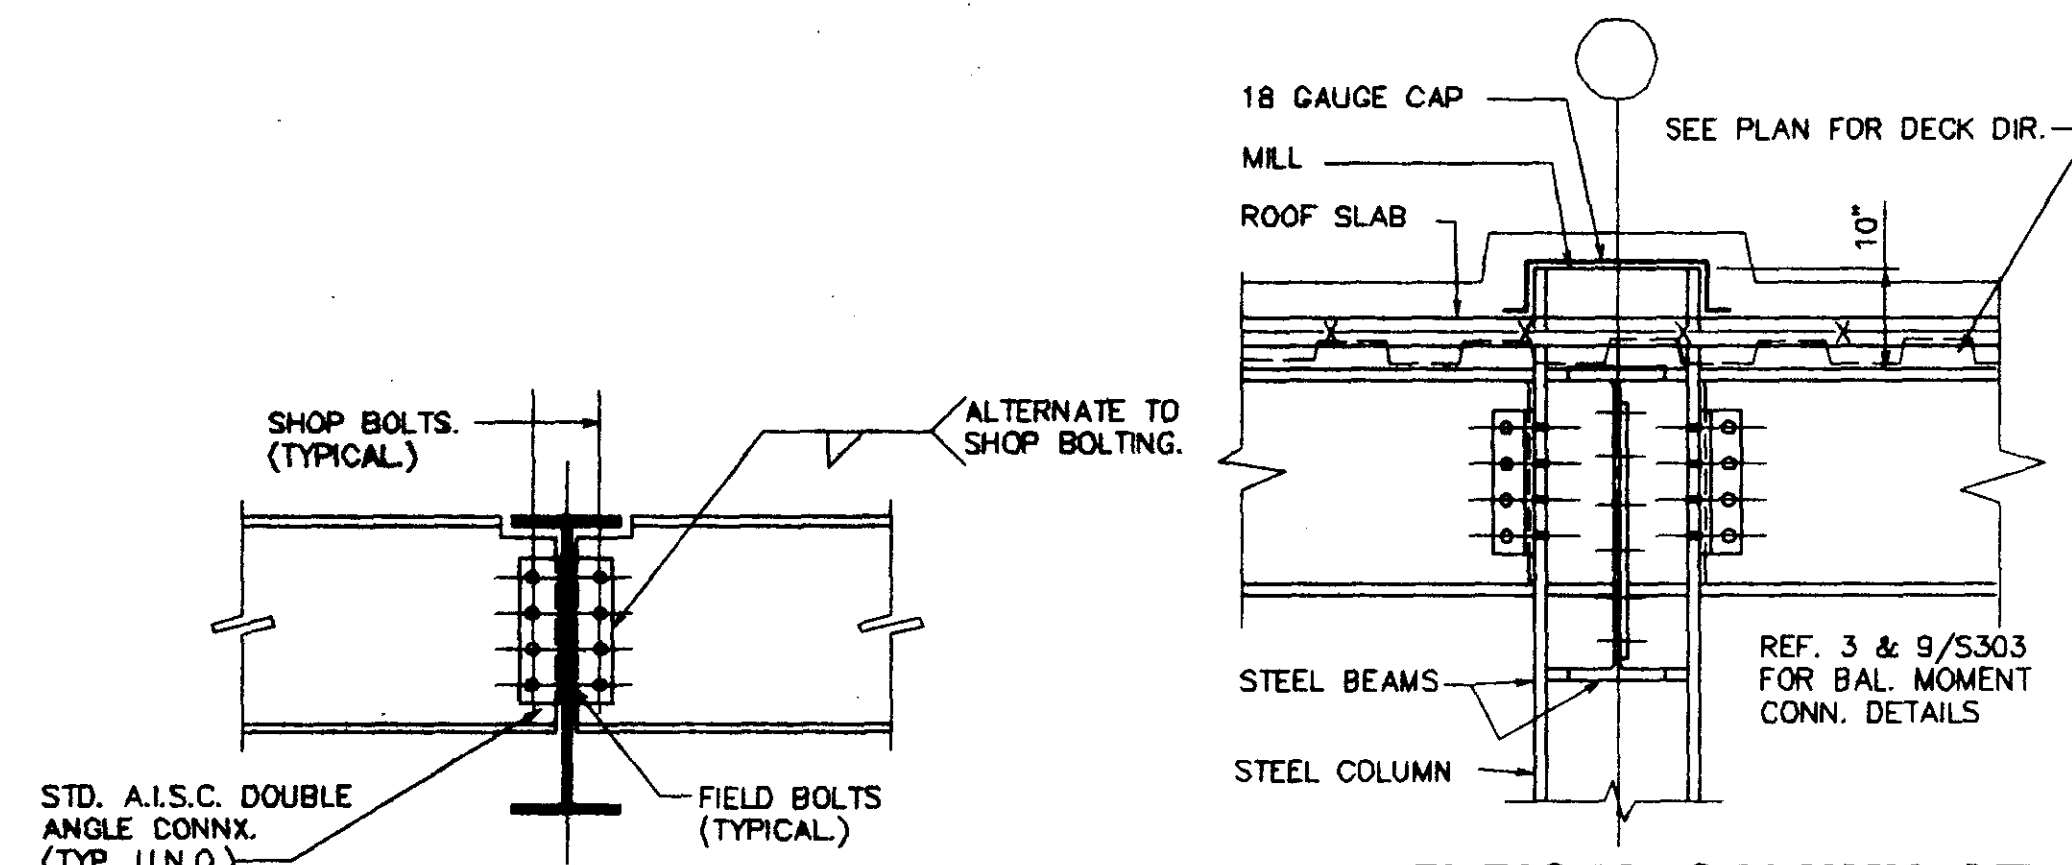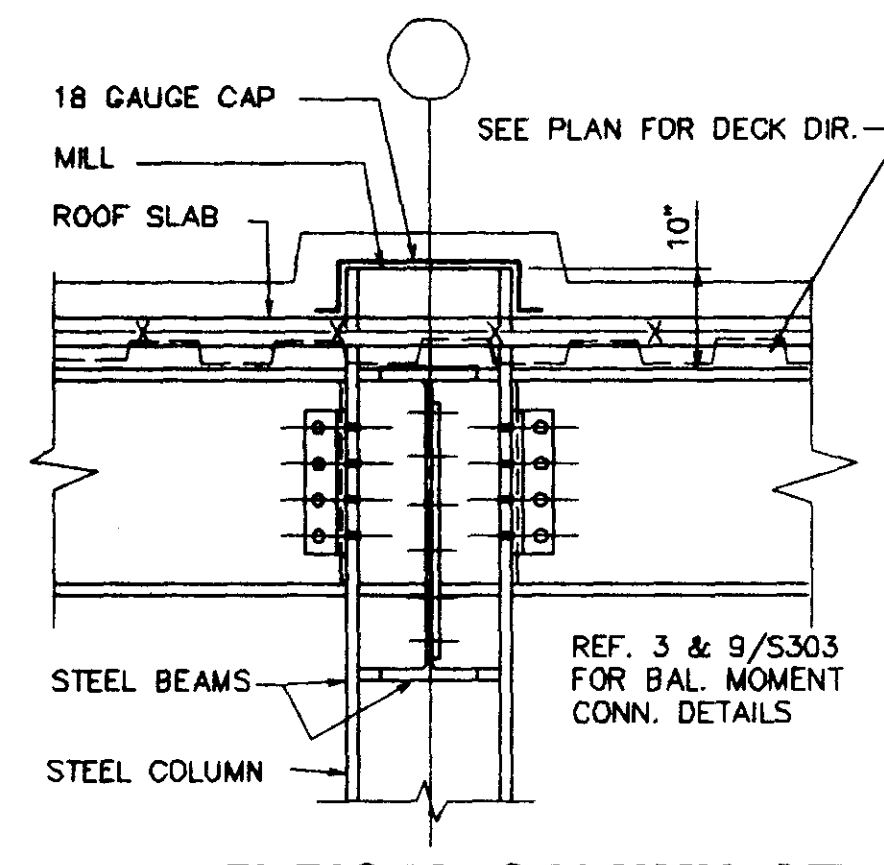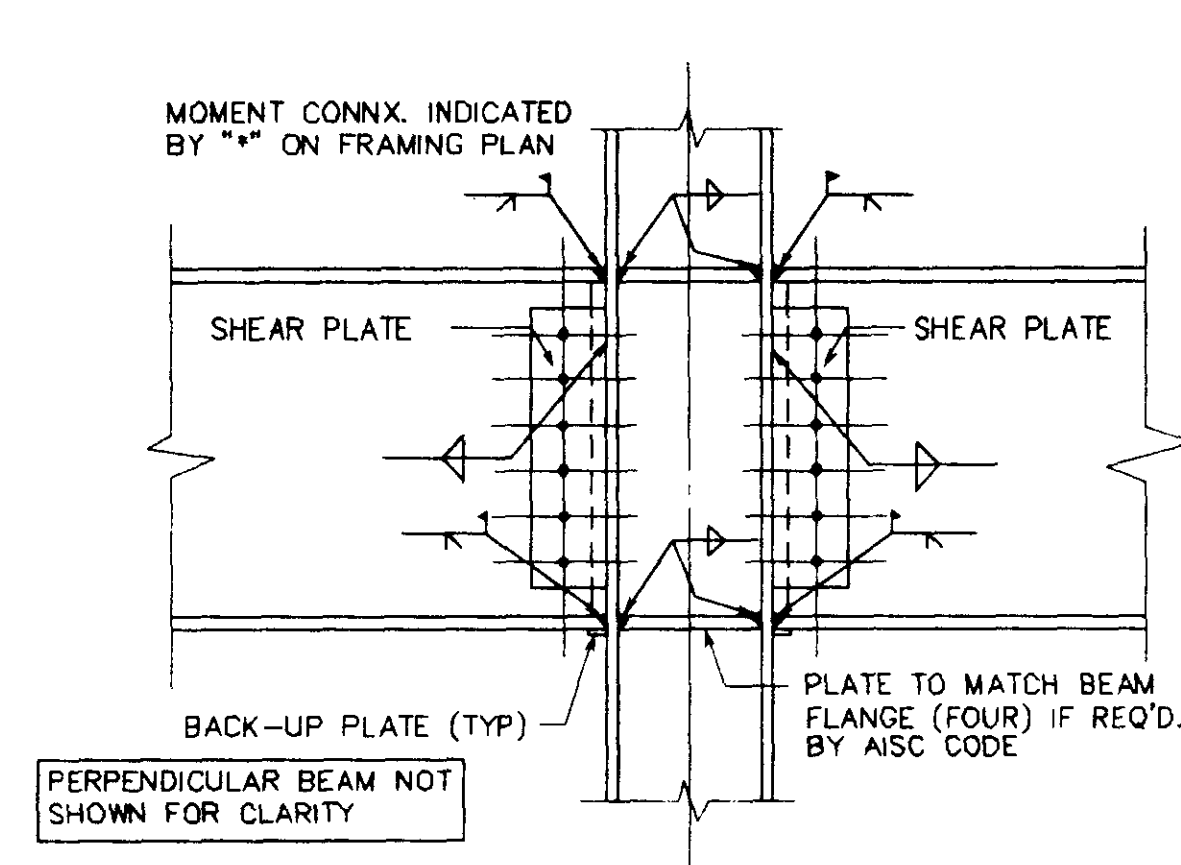**1 BEAM-TO-BEAM SHEAR CONN.****2 TYPICAL COLUMN AT ROOF DETAIL****3 FLANGE CONNECTION BM. TO COL. MOMENT CONN.**


TYPICAL AT ALL NON-COMPOSITE BEAMS FRAMING INTO WIDE FLANGE COLUMNS

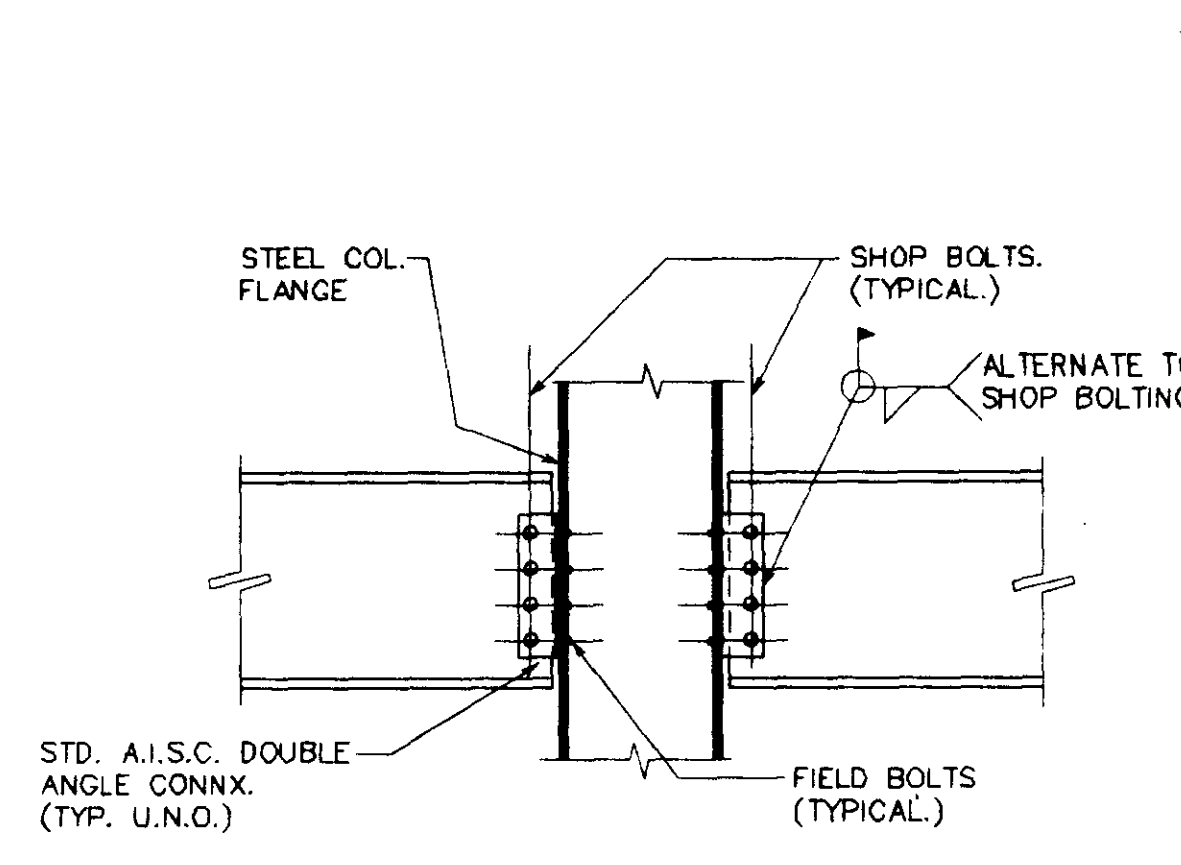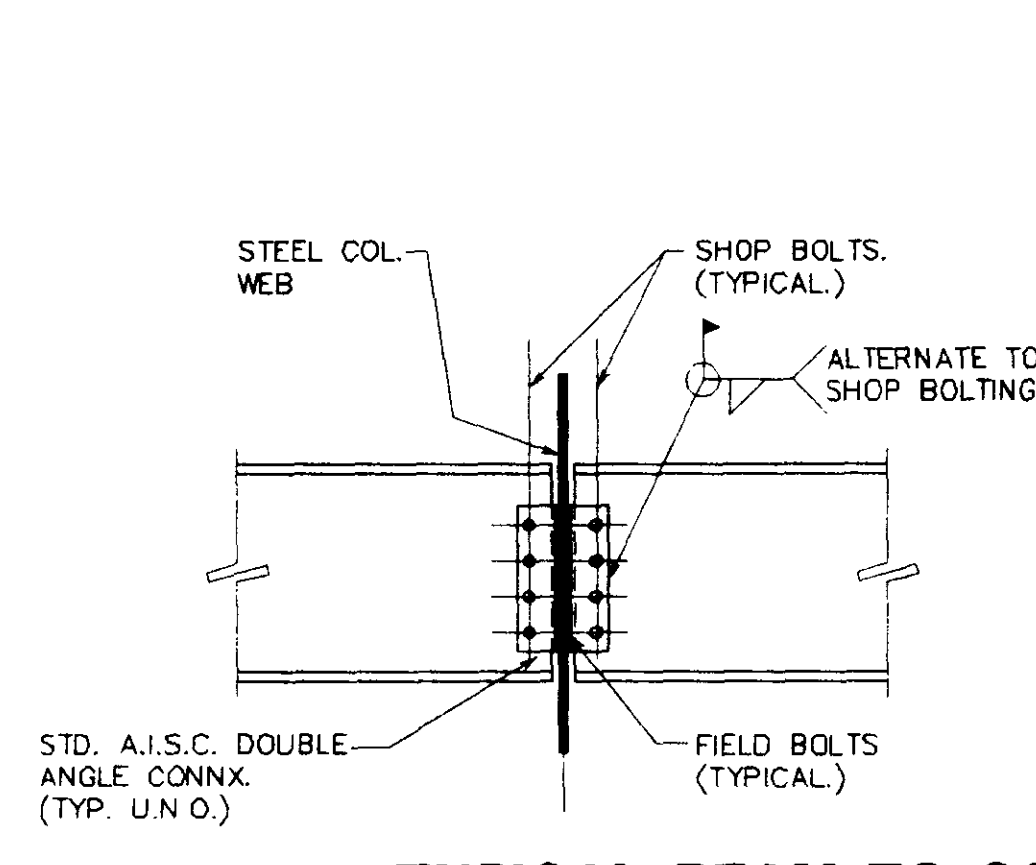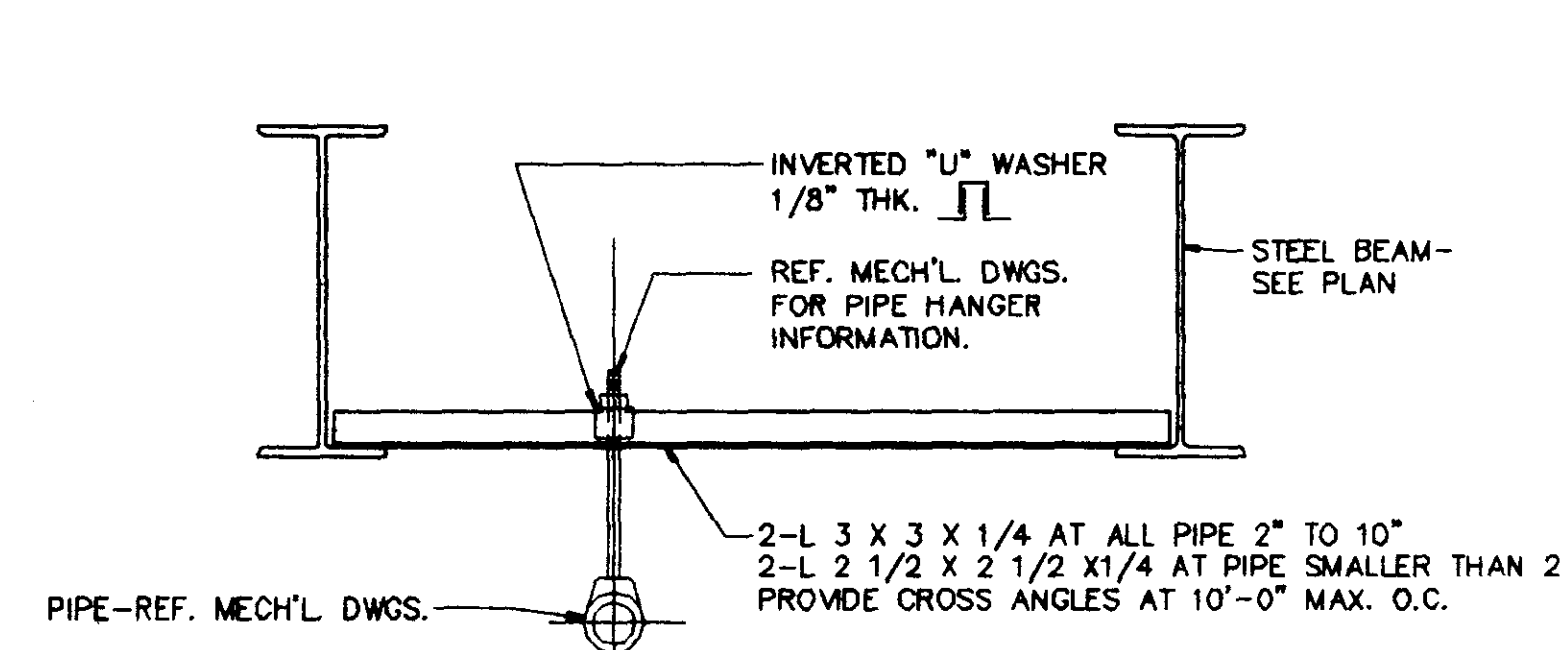**4 TYPICAL BEAM TO COLUMN SHEAR CONNECTION-FLANGE****5 TYPICAL BEAM TO COLUMN SHEAR CONNECTION-WEB****6 PIPE SUPPORT DETAIL**


NOTE: DO NOT USE THIS DETAIL FOR PIPES LARGER THAN 10" DIAMETER

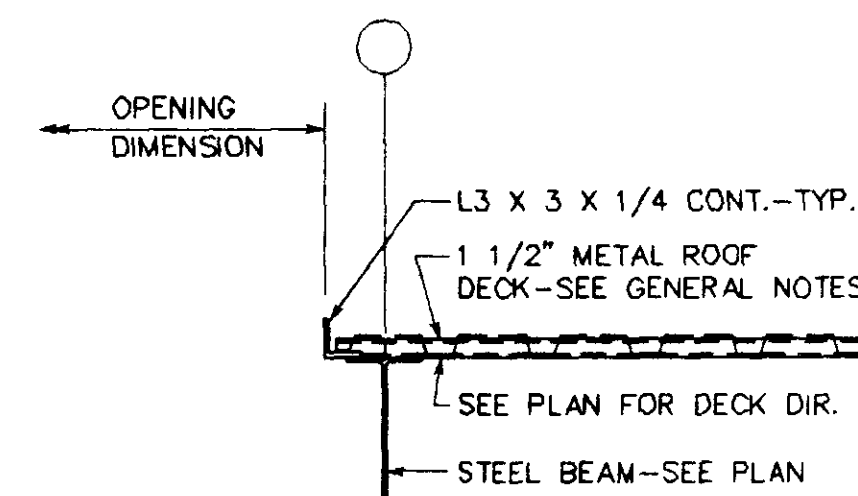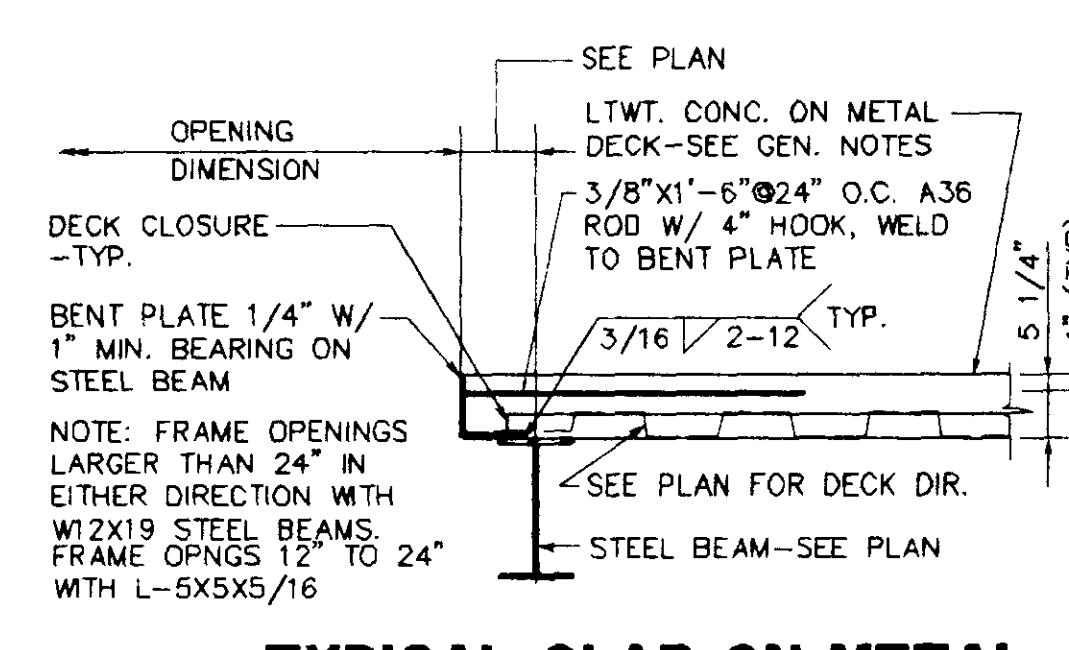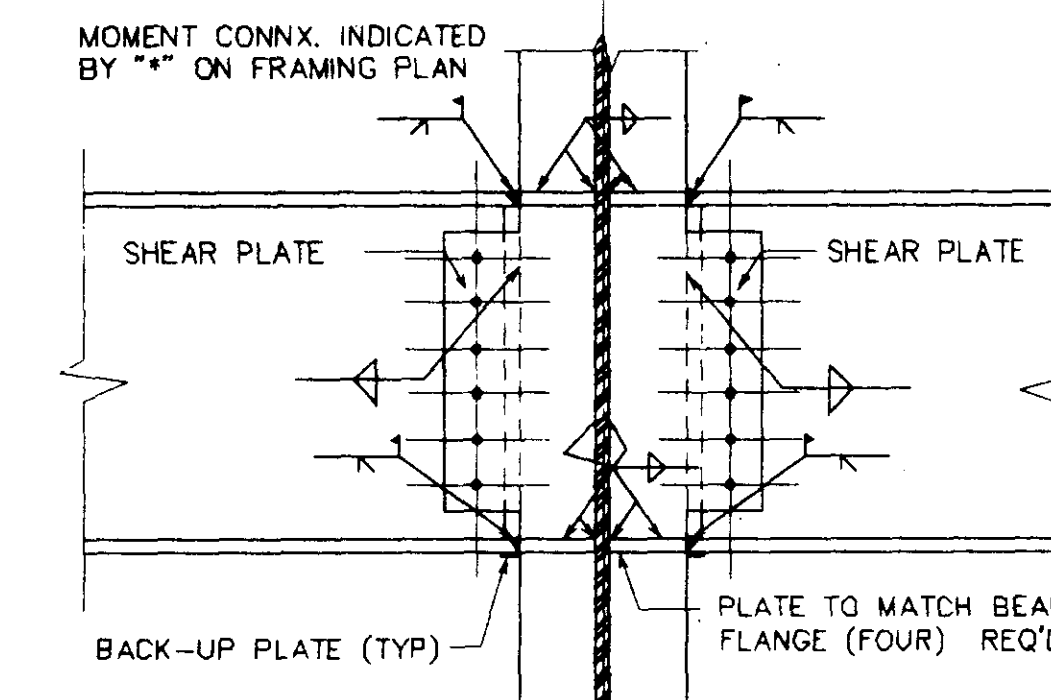**7 TYPICAL ROOF DECK OPENING DETAIL****8 TYPICAL SLAB-ON-METAL DECK OPENING DETAIL****9 WEB CONNECTION BM. TO COL. MOMENT CONN.**




TYPICAL AT ALL NON-COMPOSITE BEAMS FRAMING INTO WIDE FLANGE COLUMNS

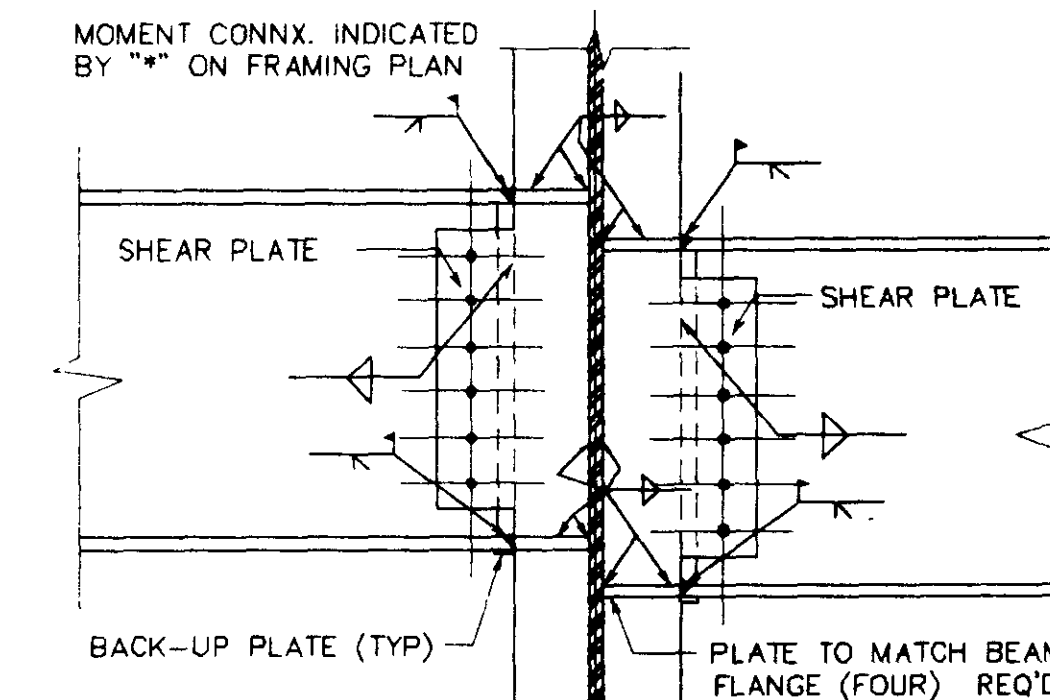**10 WEB CONNECTION BM. TO COL. MOMENT CONN.**

TYPICAL AT ALL NON-COMPOSITE BEAMS FRAMING INTO WIDE FLANGE COLUMNS

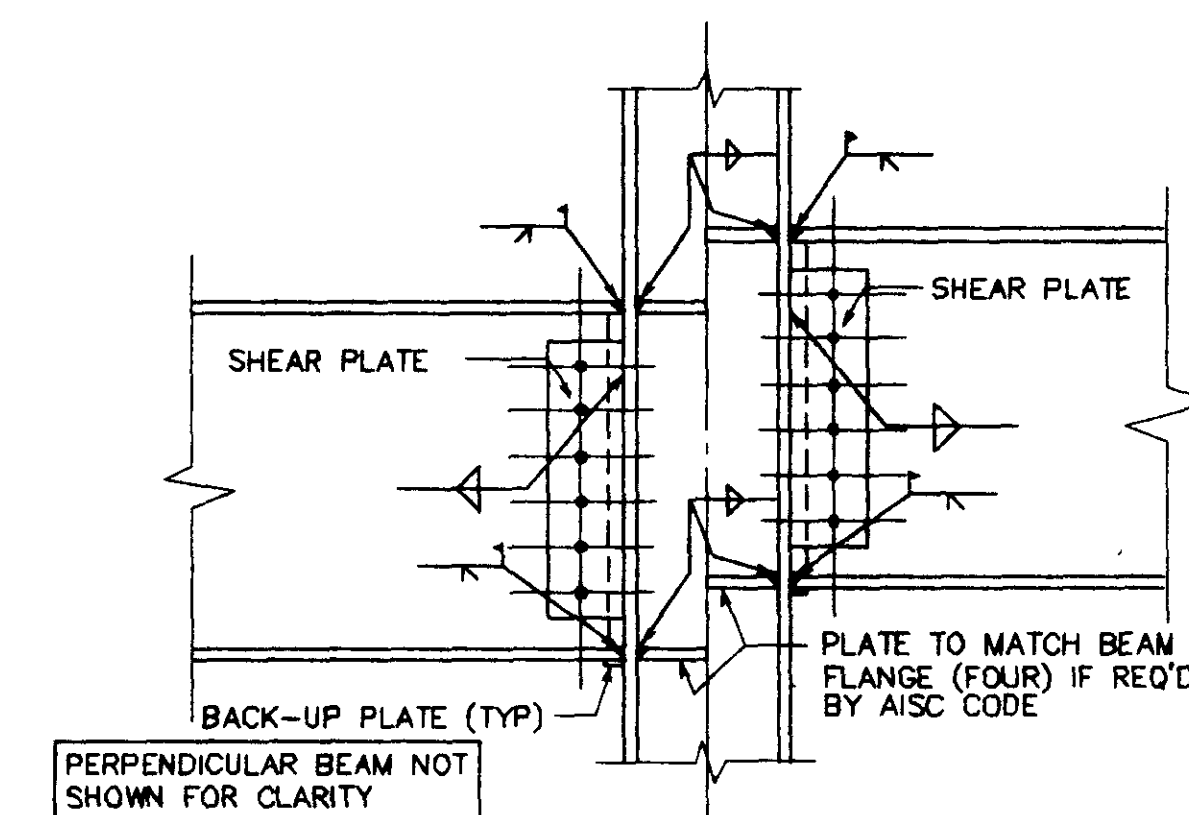**11 FLANGE CONNECTION BM. TO COL. MOMENT CONN.**

TYPICAL AT ALL NON-COMPOSITE BEAMS FRAMING INTO WIDE FLANGE COLUMNS

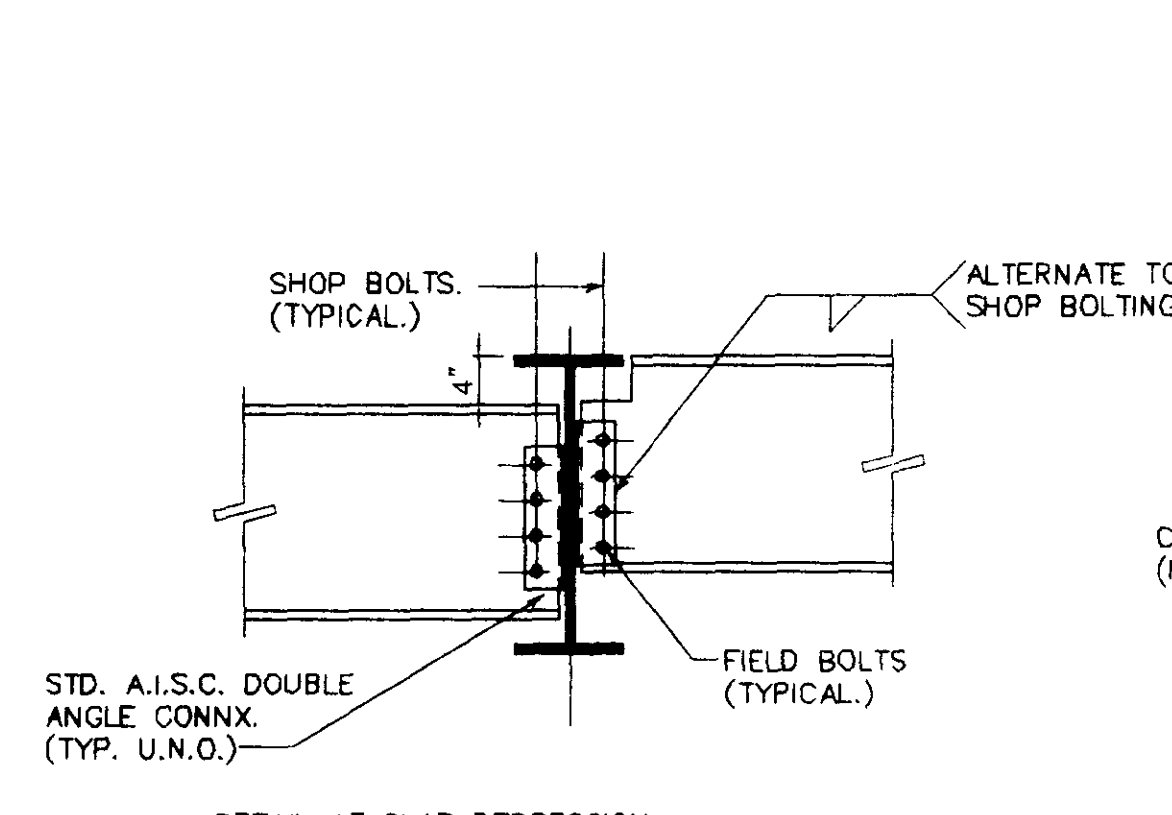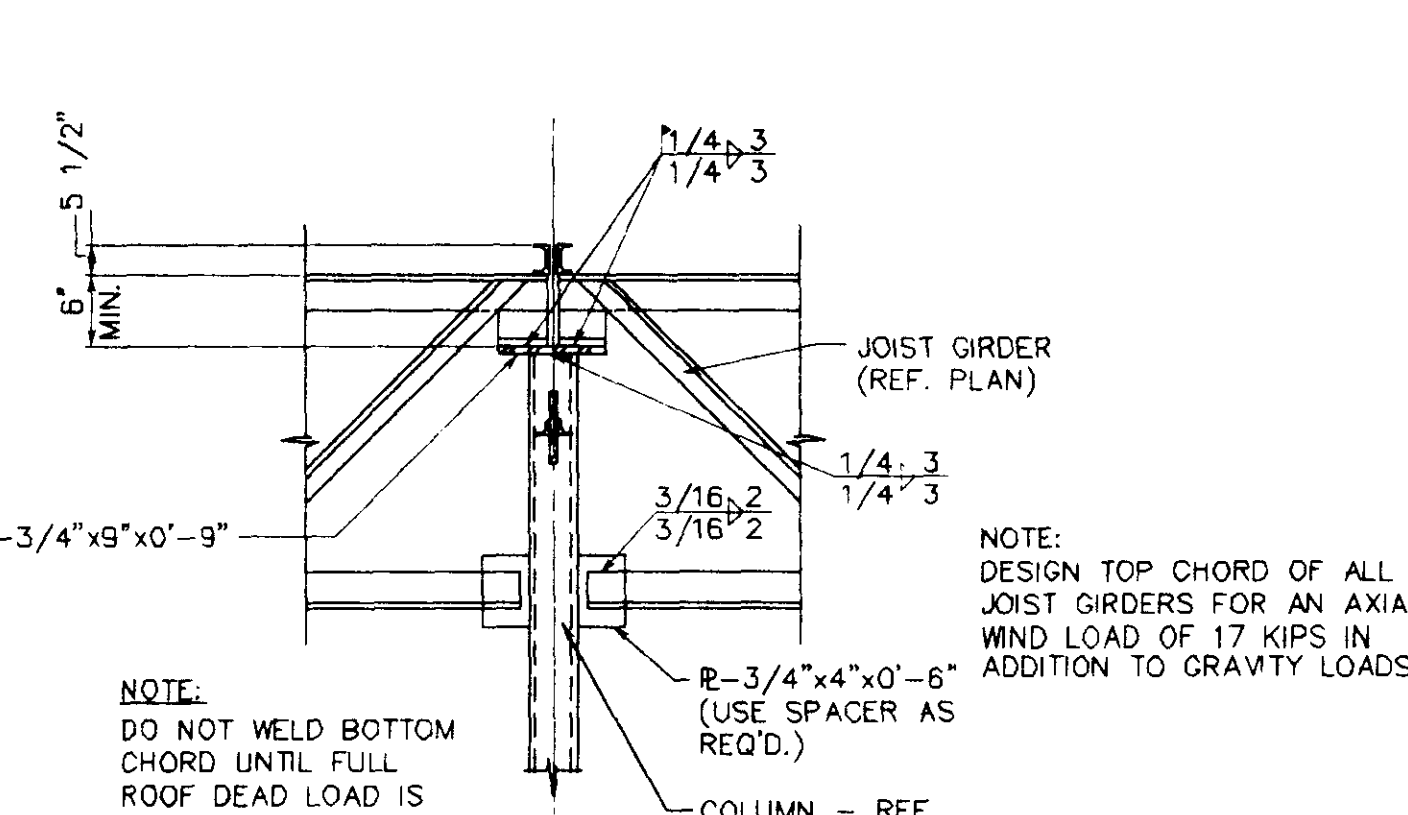
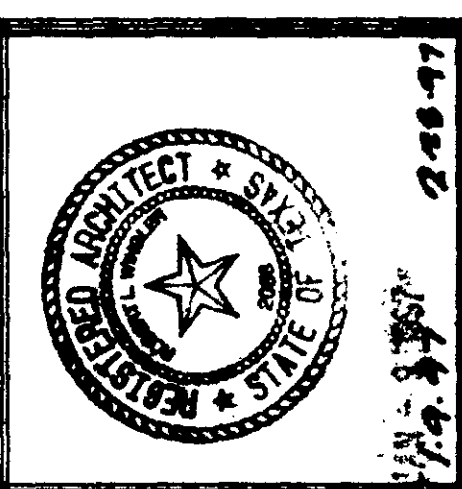
**12 BEAM-TO-BEAM SHEAR CONN.****13 JOIST GIRDER TO COLUMN CONN.**

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SECTIONS AND DETAILS

JANUARY 2, 1987

8303

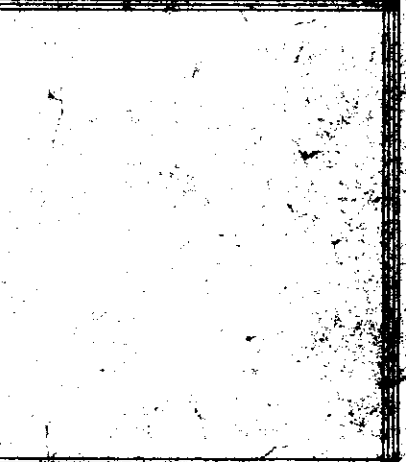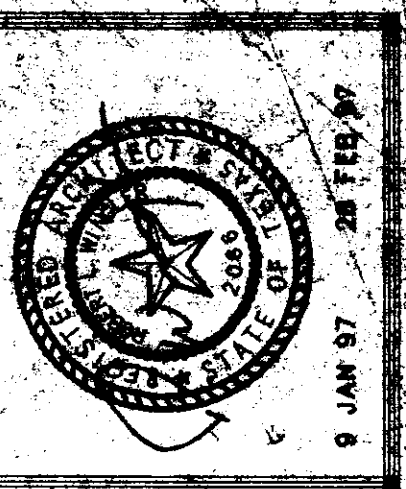


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WICHITA FALLS, TEXAS

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FIRST FLOOR PLAN

JAN 9 1997

Sheet No.:
A1.01
1 of 11

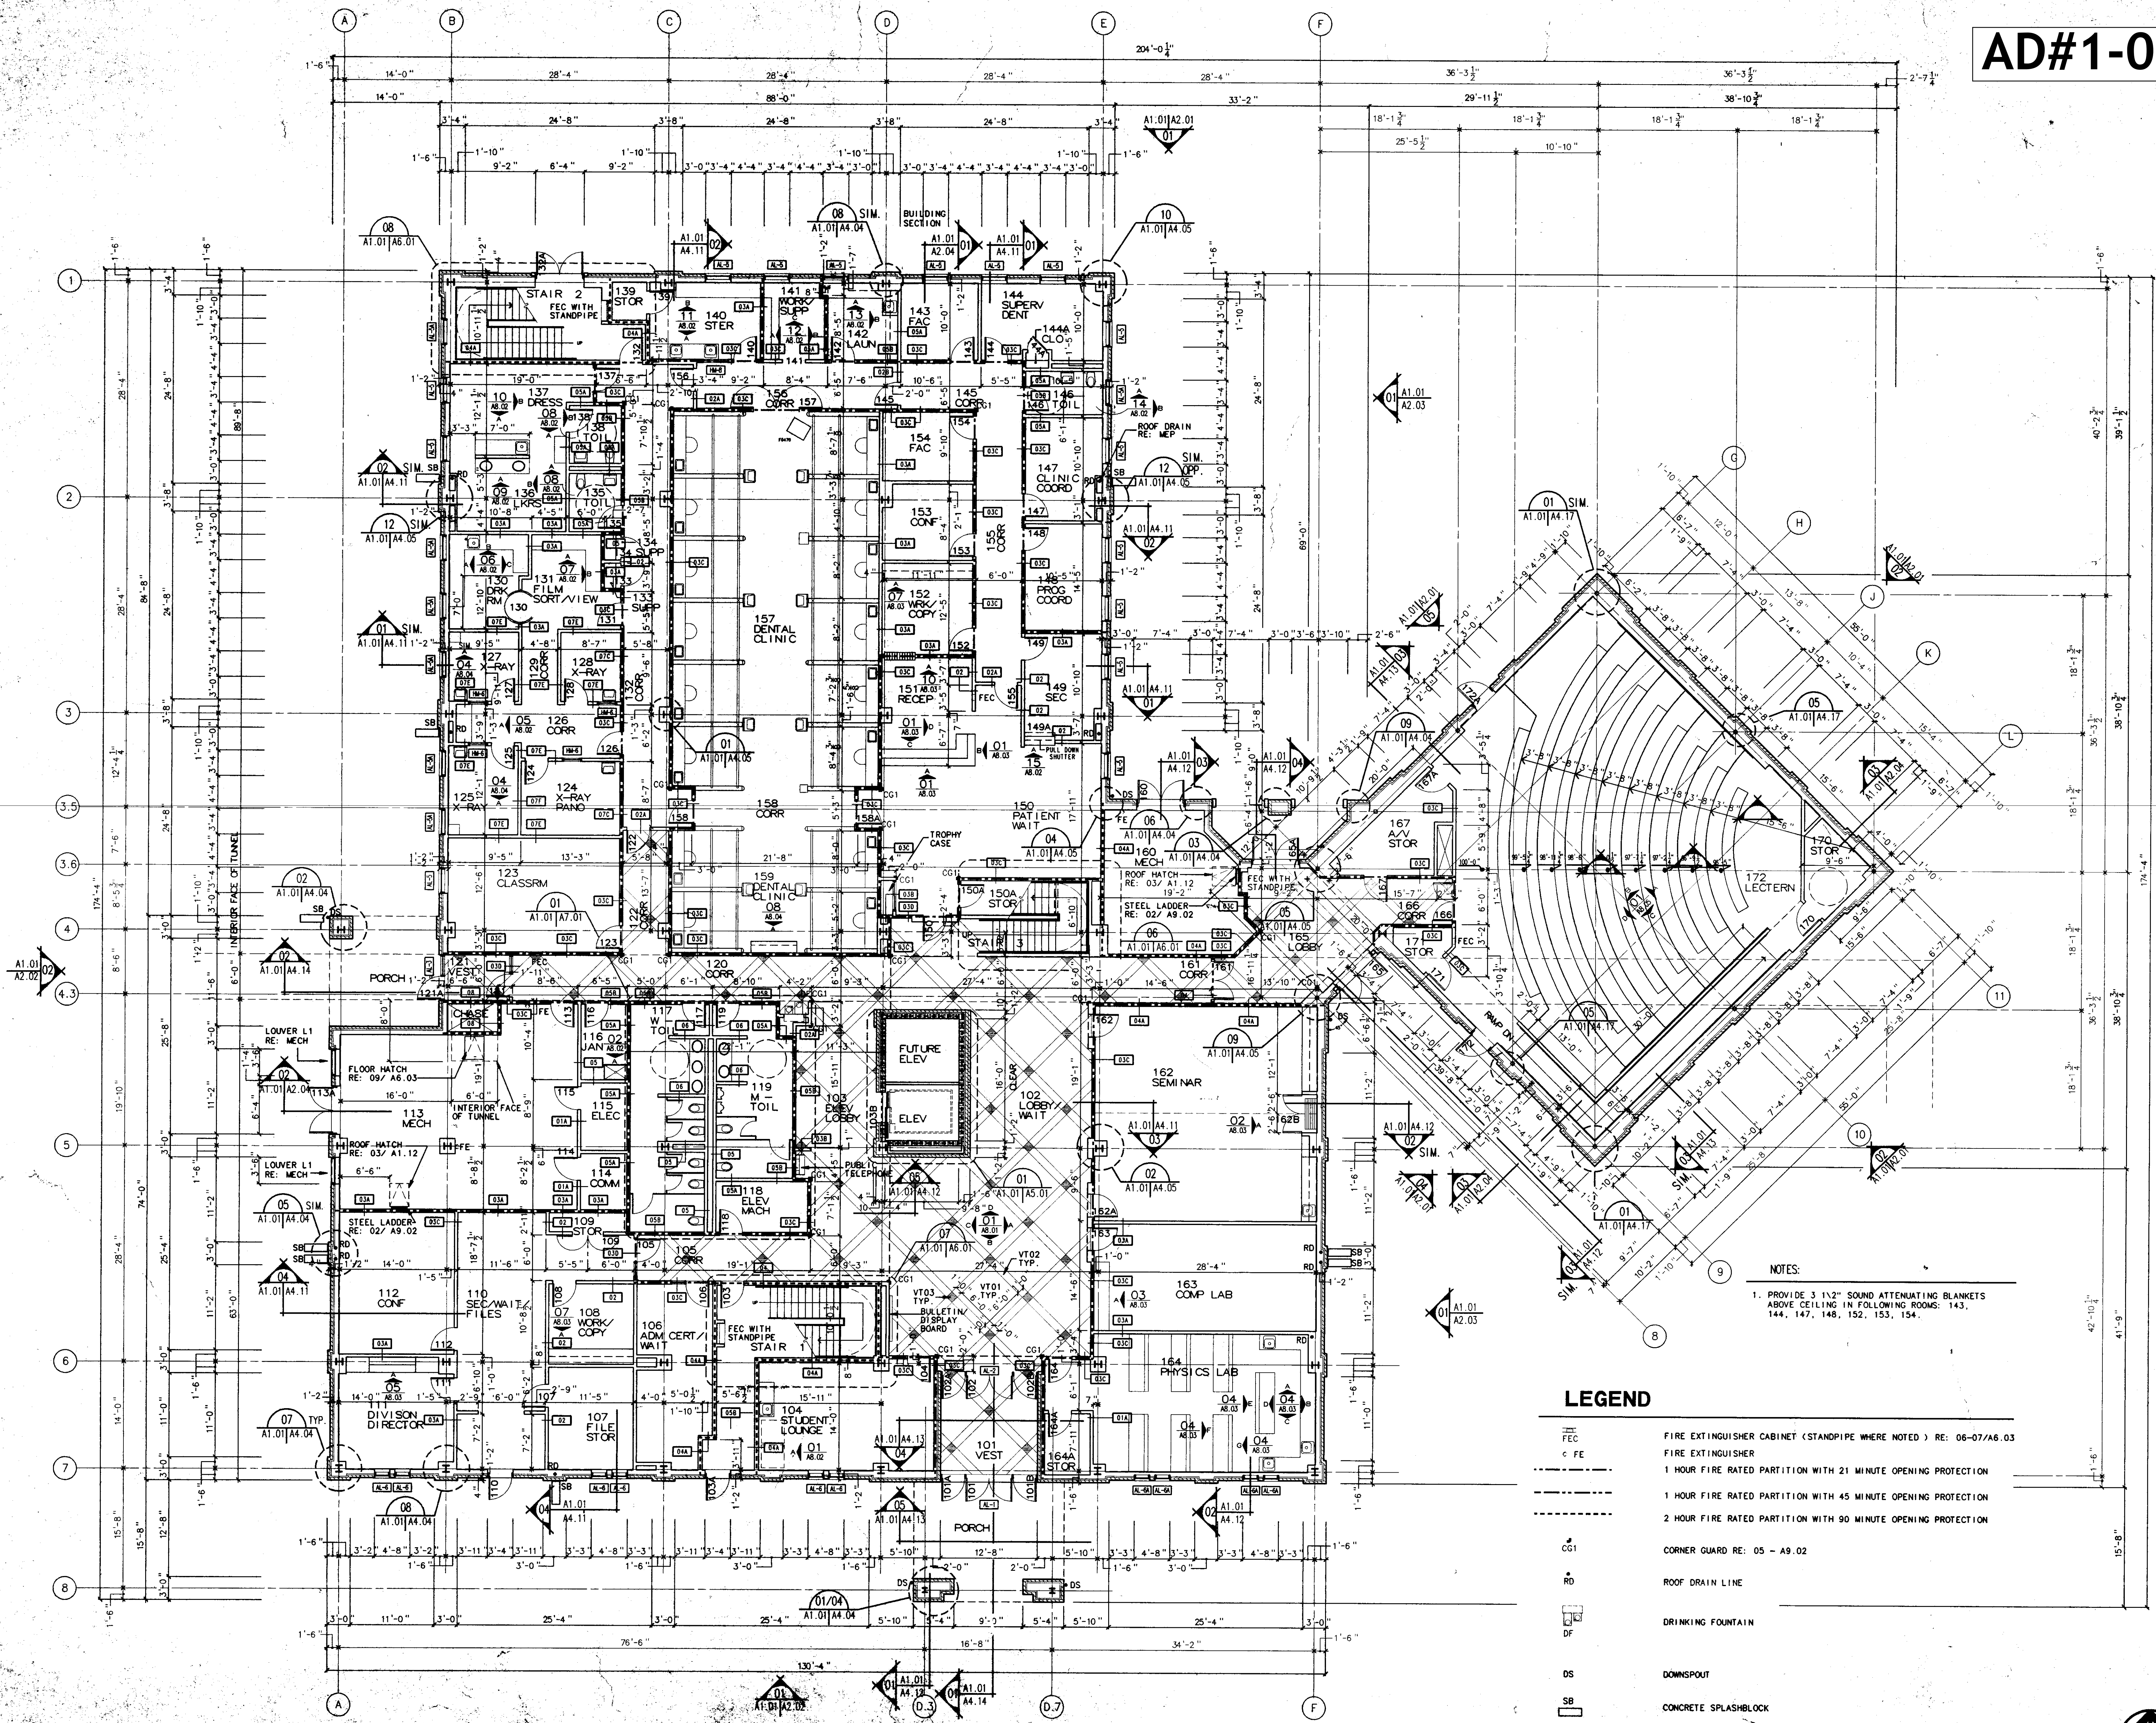




NOTES:
1. PROVIDE 3 1/2" SOUND ATTENUATING BLANKETS ABOVE CEILING IN FOLLOWING ROOMS: 143, 144, 147, 148, 152, 153, 154.

LEGEND

- FEC FIRE EXTINGUISHER CABINET (STANDPIPE WHERE NOTED) RE: 06-07/A6.03
- FE FIRE EXTINGUISHER
- 1 HOUR FIRE RATED PARTITION WITH 21 MINUTE OPENING PROTECTION
- 1 HOUR FIRE RATED PARTITION WITH 45 MINUTE OPENING PROTECTION
- 2 HOUR FIRE RATED PARTITION WITH 90 MINUTE OPENING PROTECTION
- CG1 CORNER GUARD RE: 05 - A9.02
- RD ROOF DRAIN LINE
- DF DRINKING FOUNTAIN
- DS DOWNSPOUT
- SB CONCRETE SPLASHBLOCK


FIRST FLOOR PLAN

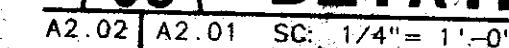

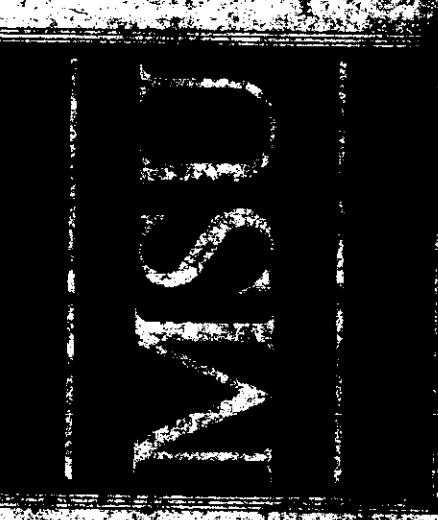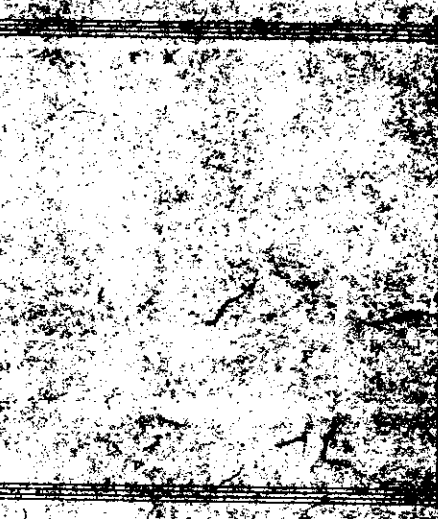


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WINTERS, TEXAS


WINNERS SHARP
ARCHITECTS & PLANNERS, INC.
BUILDING SECTIONS

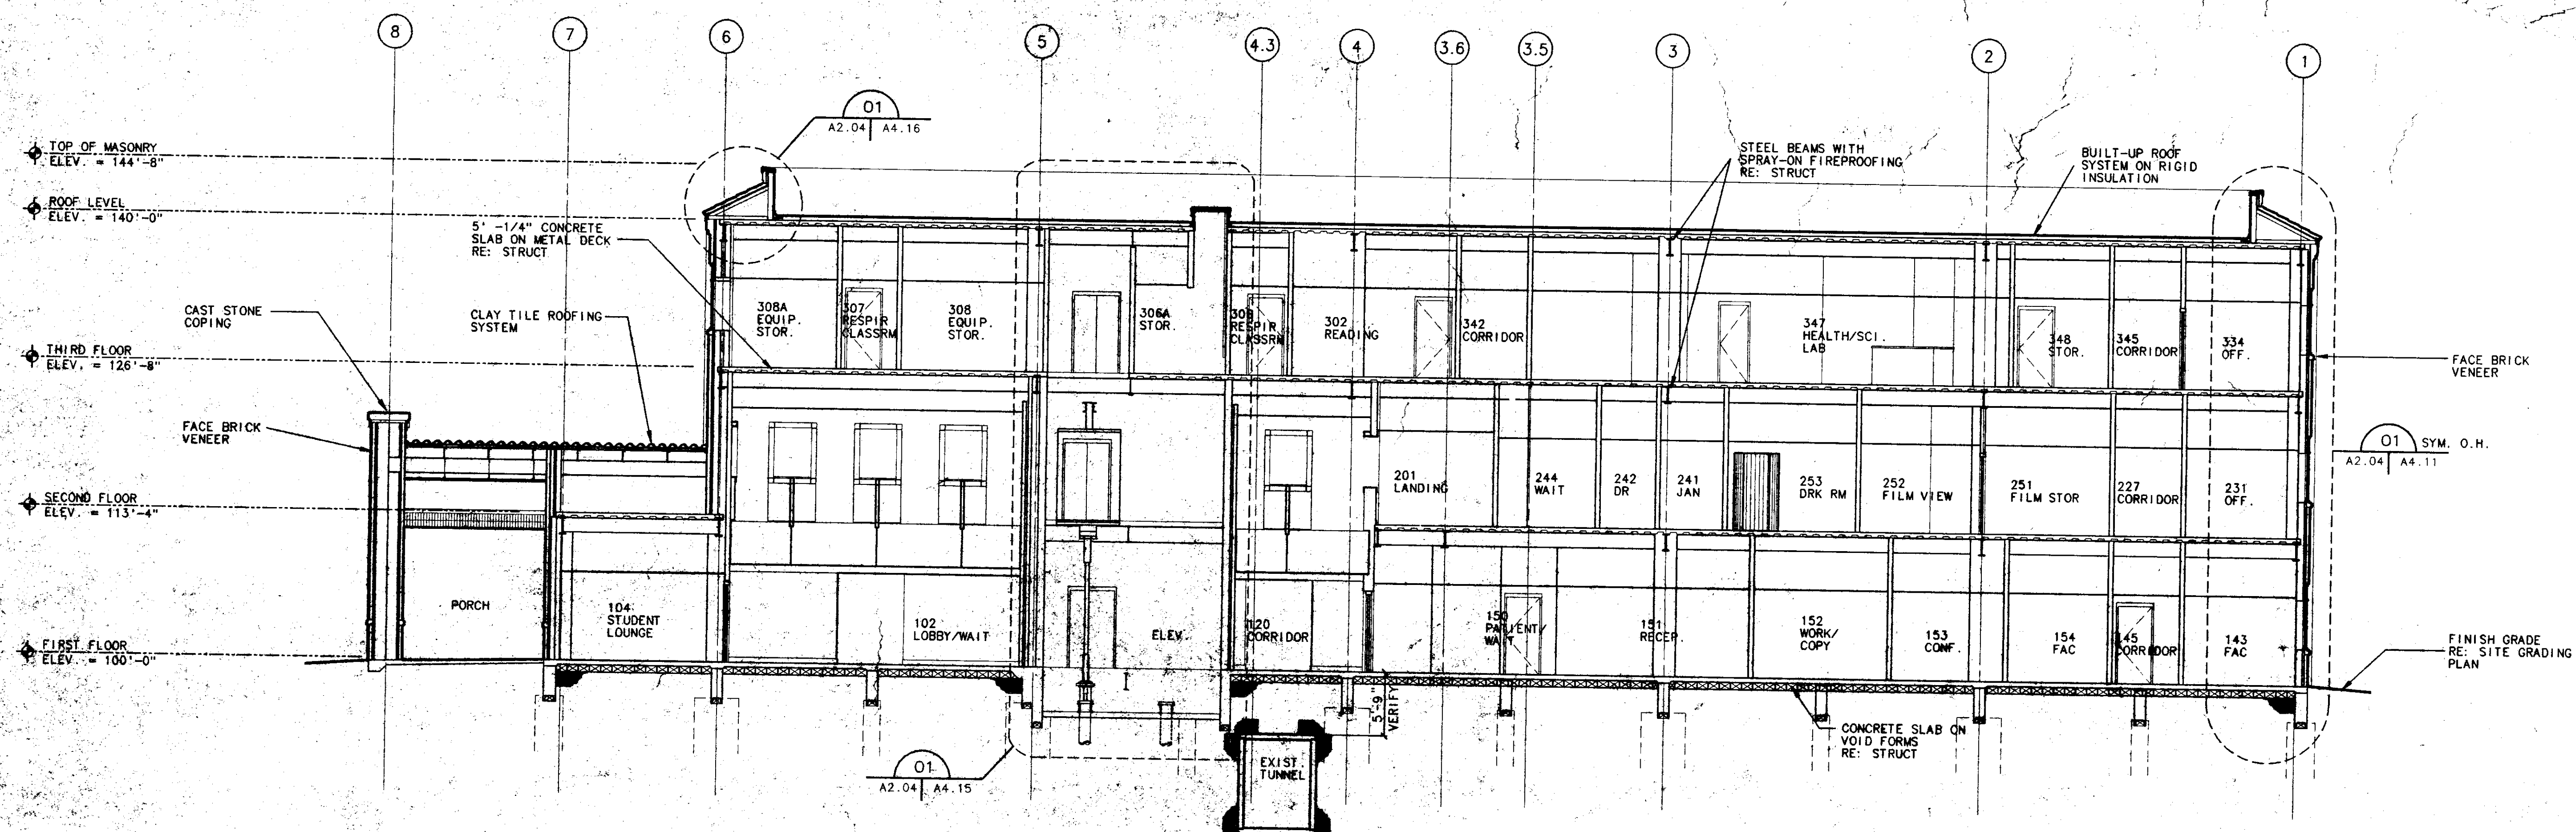

01 BUILDING SECTION
A1.01 A2.04 SCALE: 1/8" = 1'-0"
A1.02
A1.03


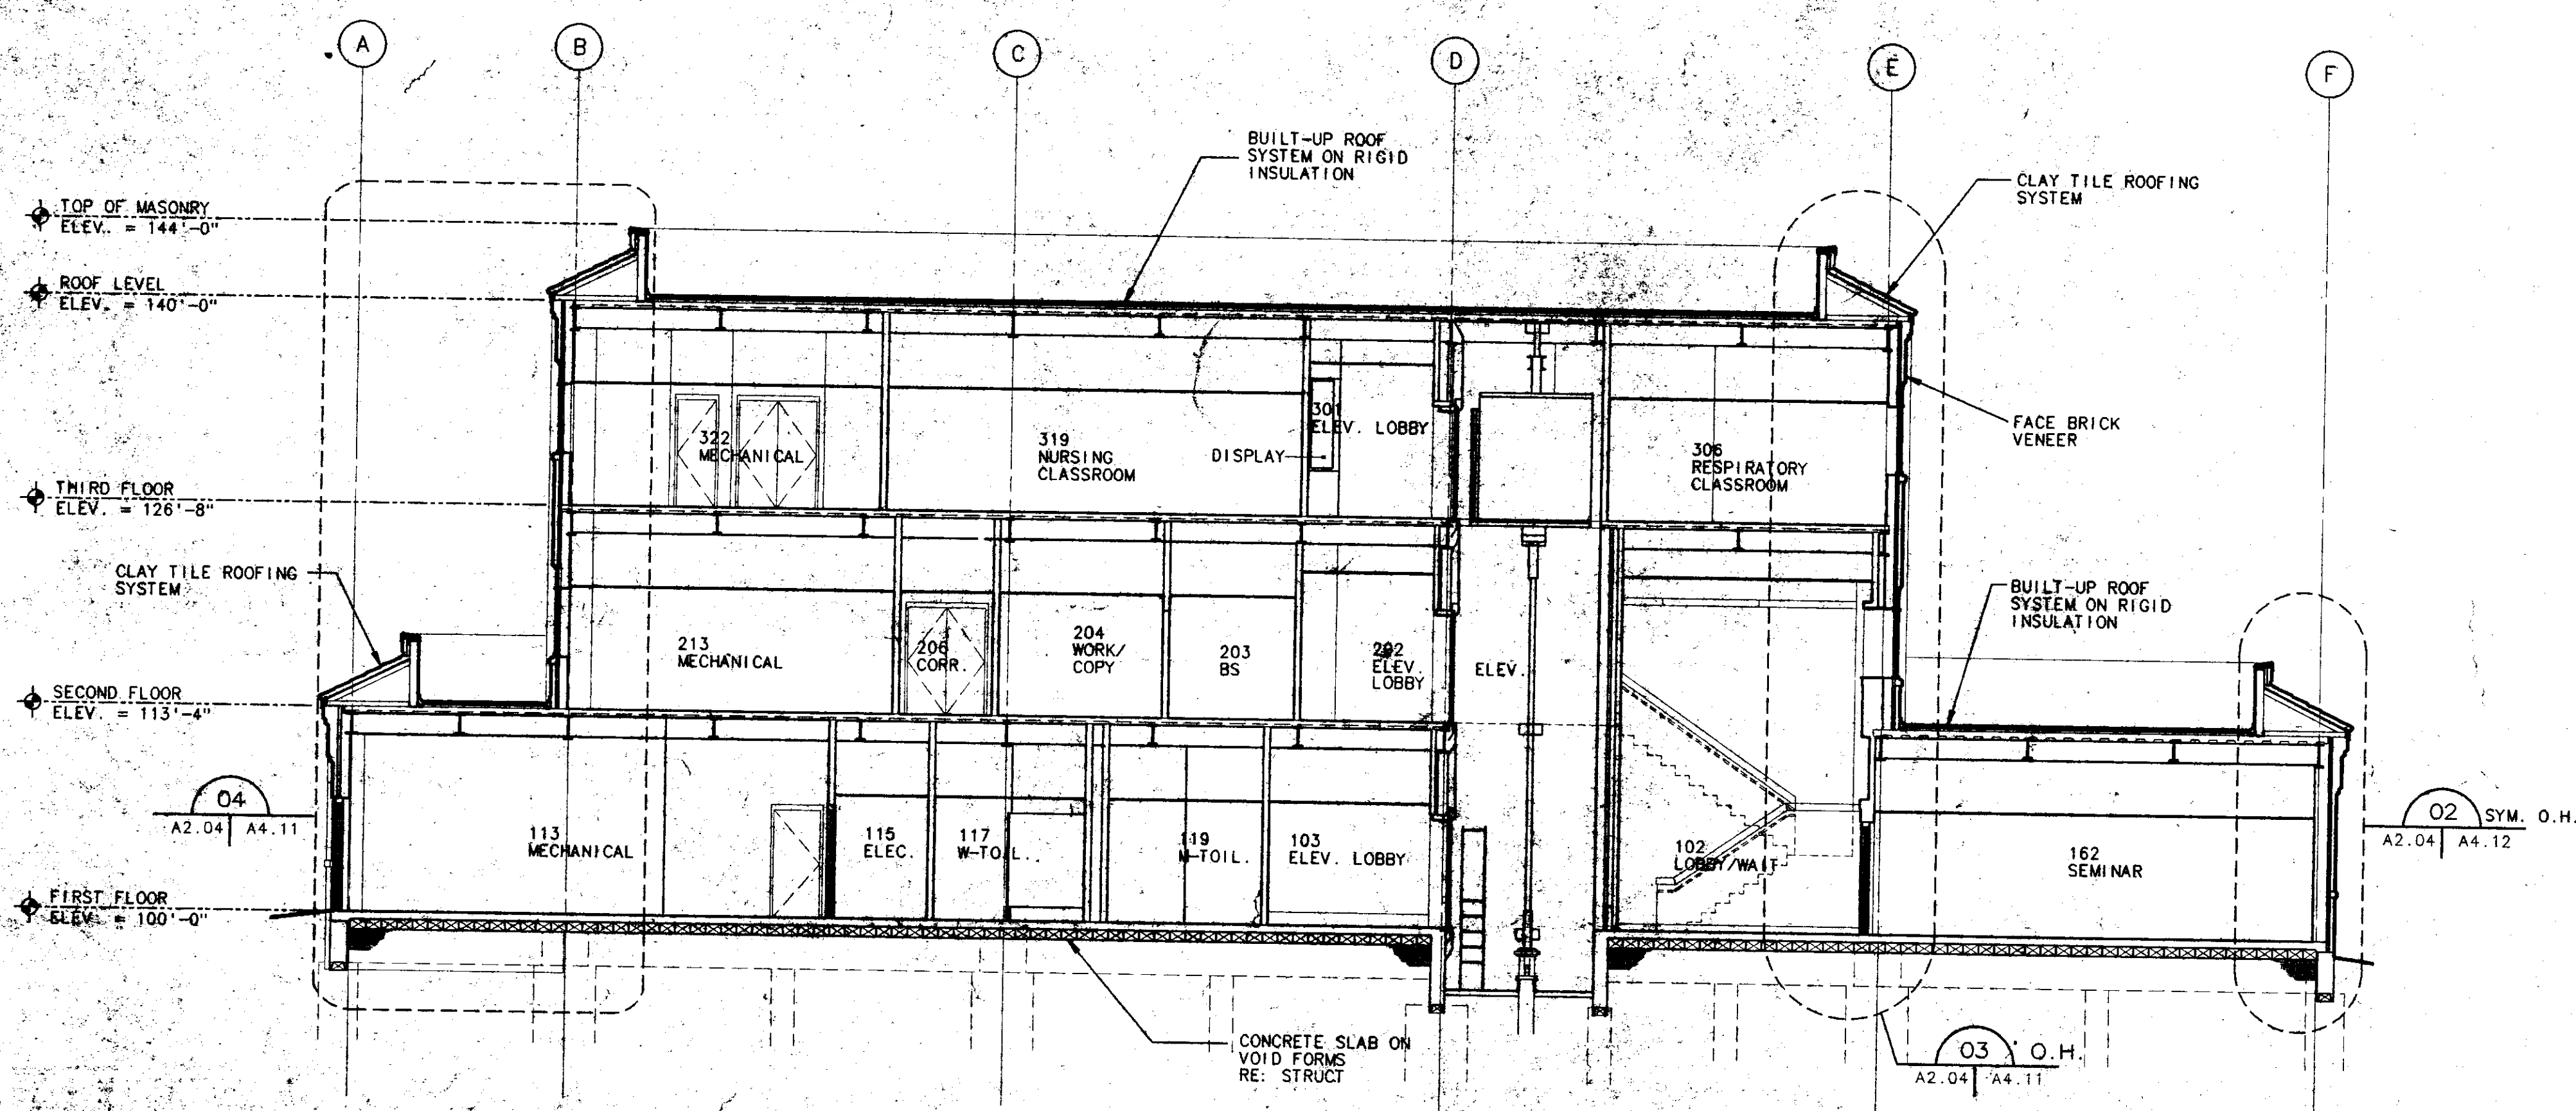


02 BUILDING SECTION
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A1.02
A1.03
A2.02

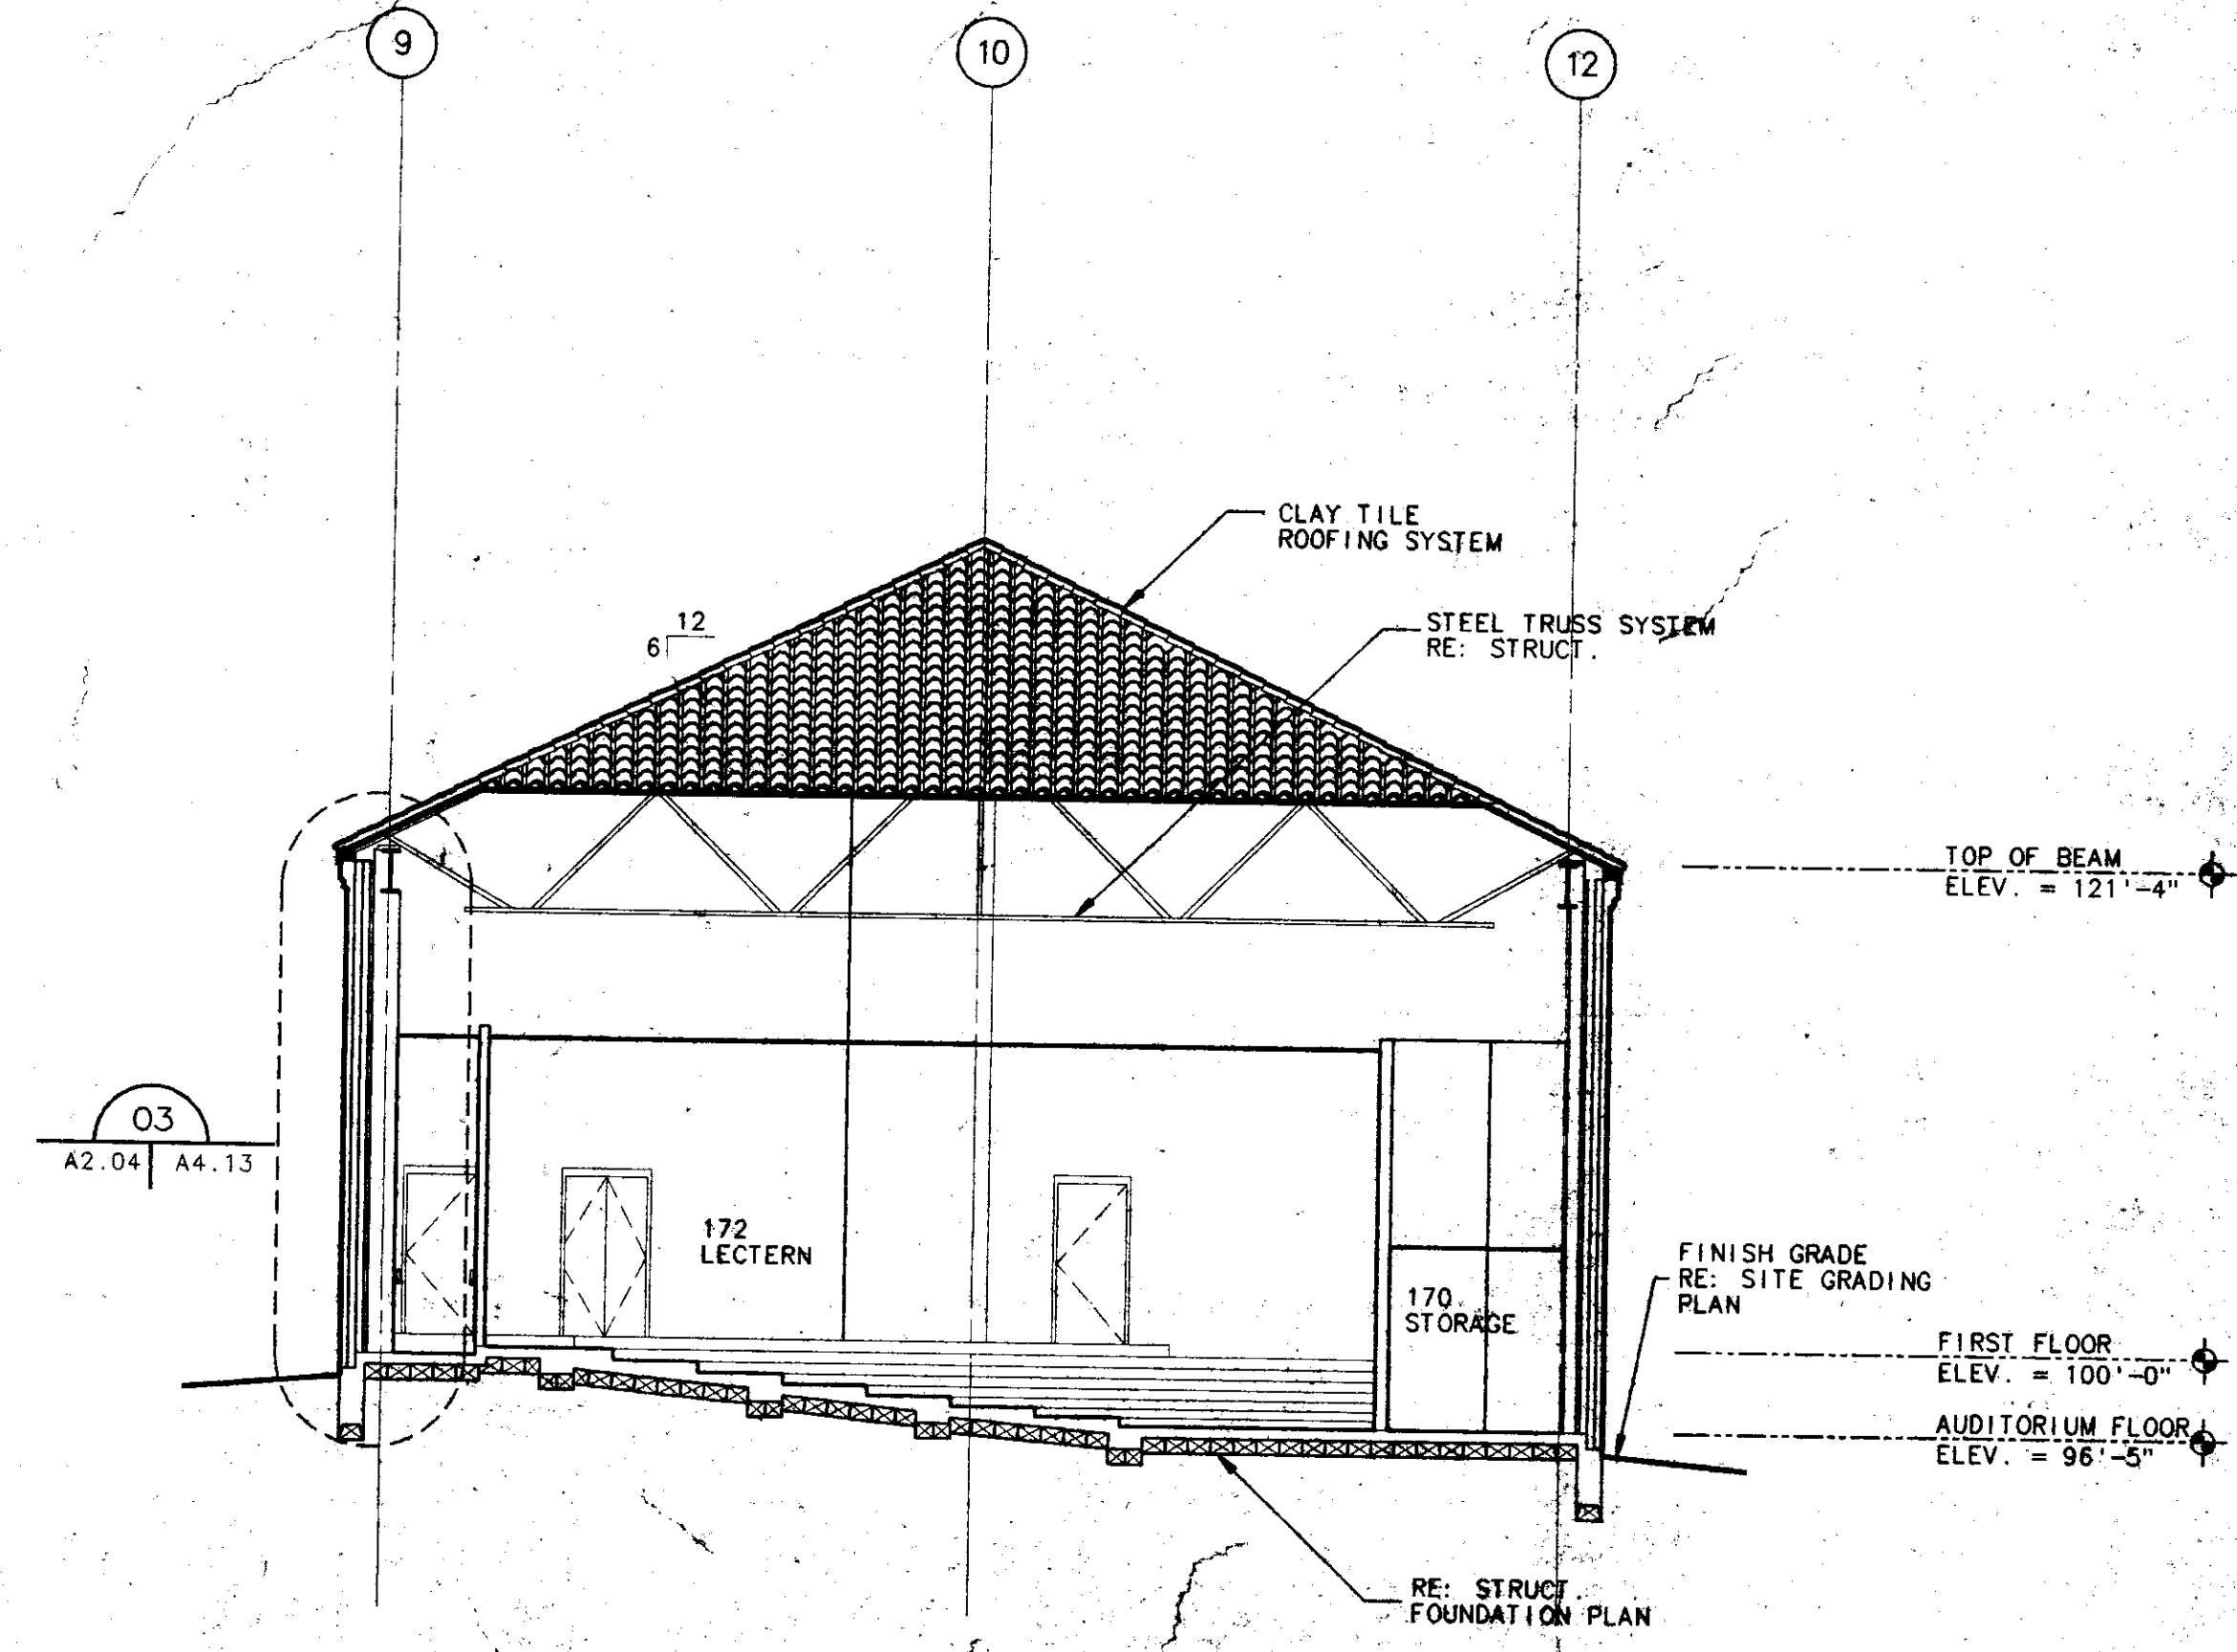


03 BUILDING SECTION
A1.01 A2.04 SCALE: 1/8" = 1'-0"
A2.04/A4.13

AD#1-07

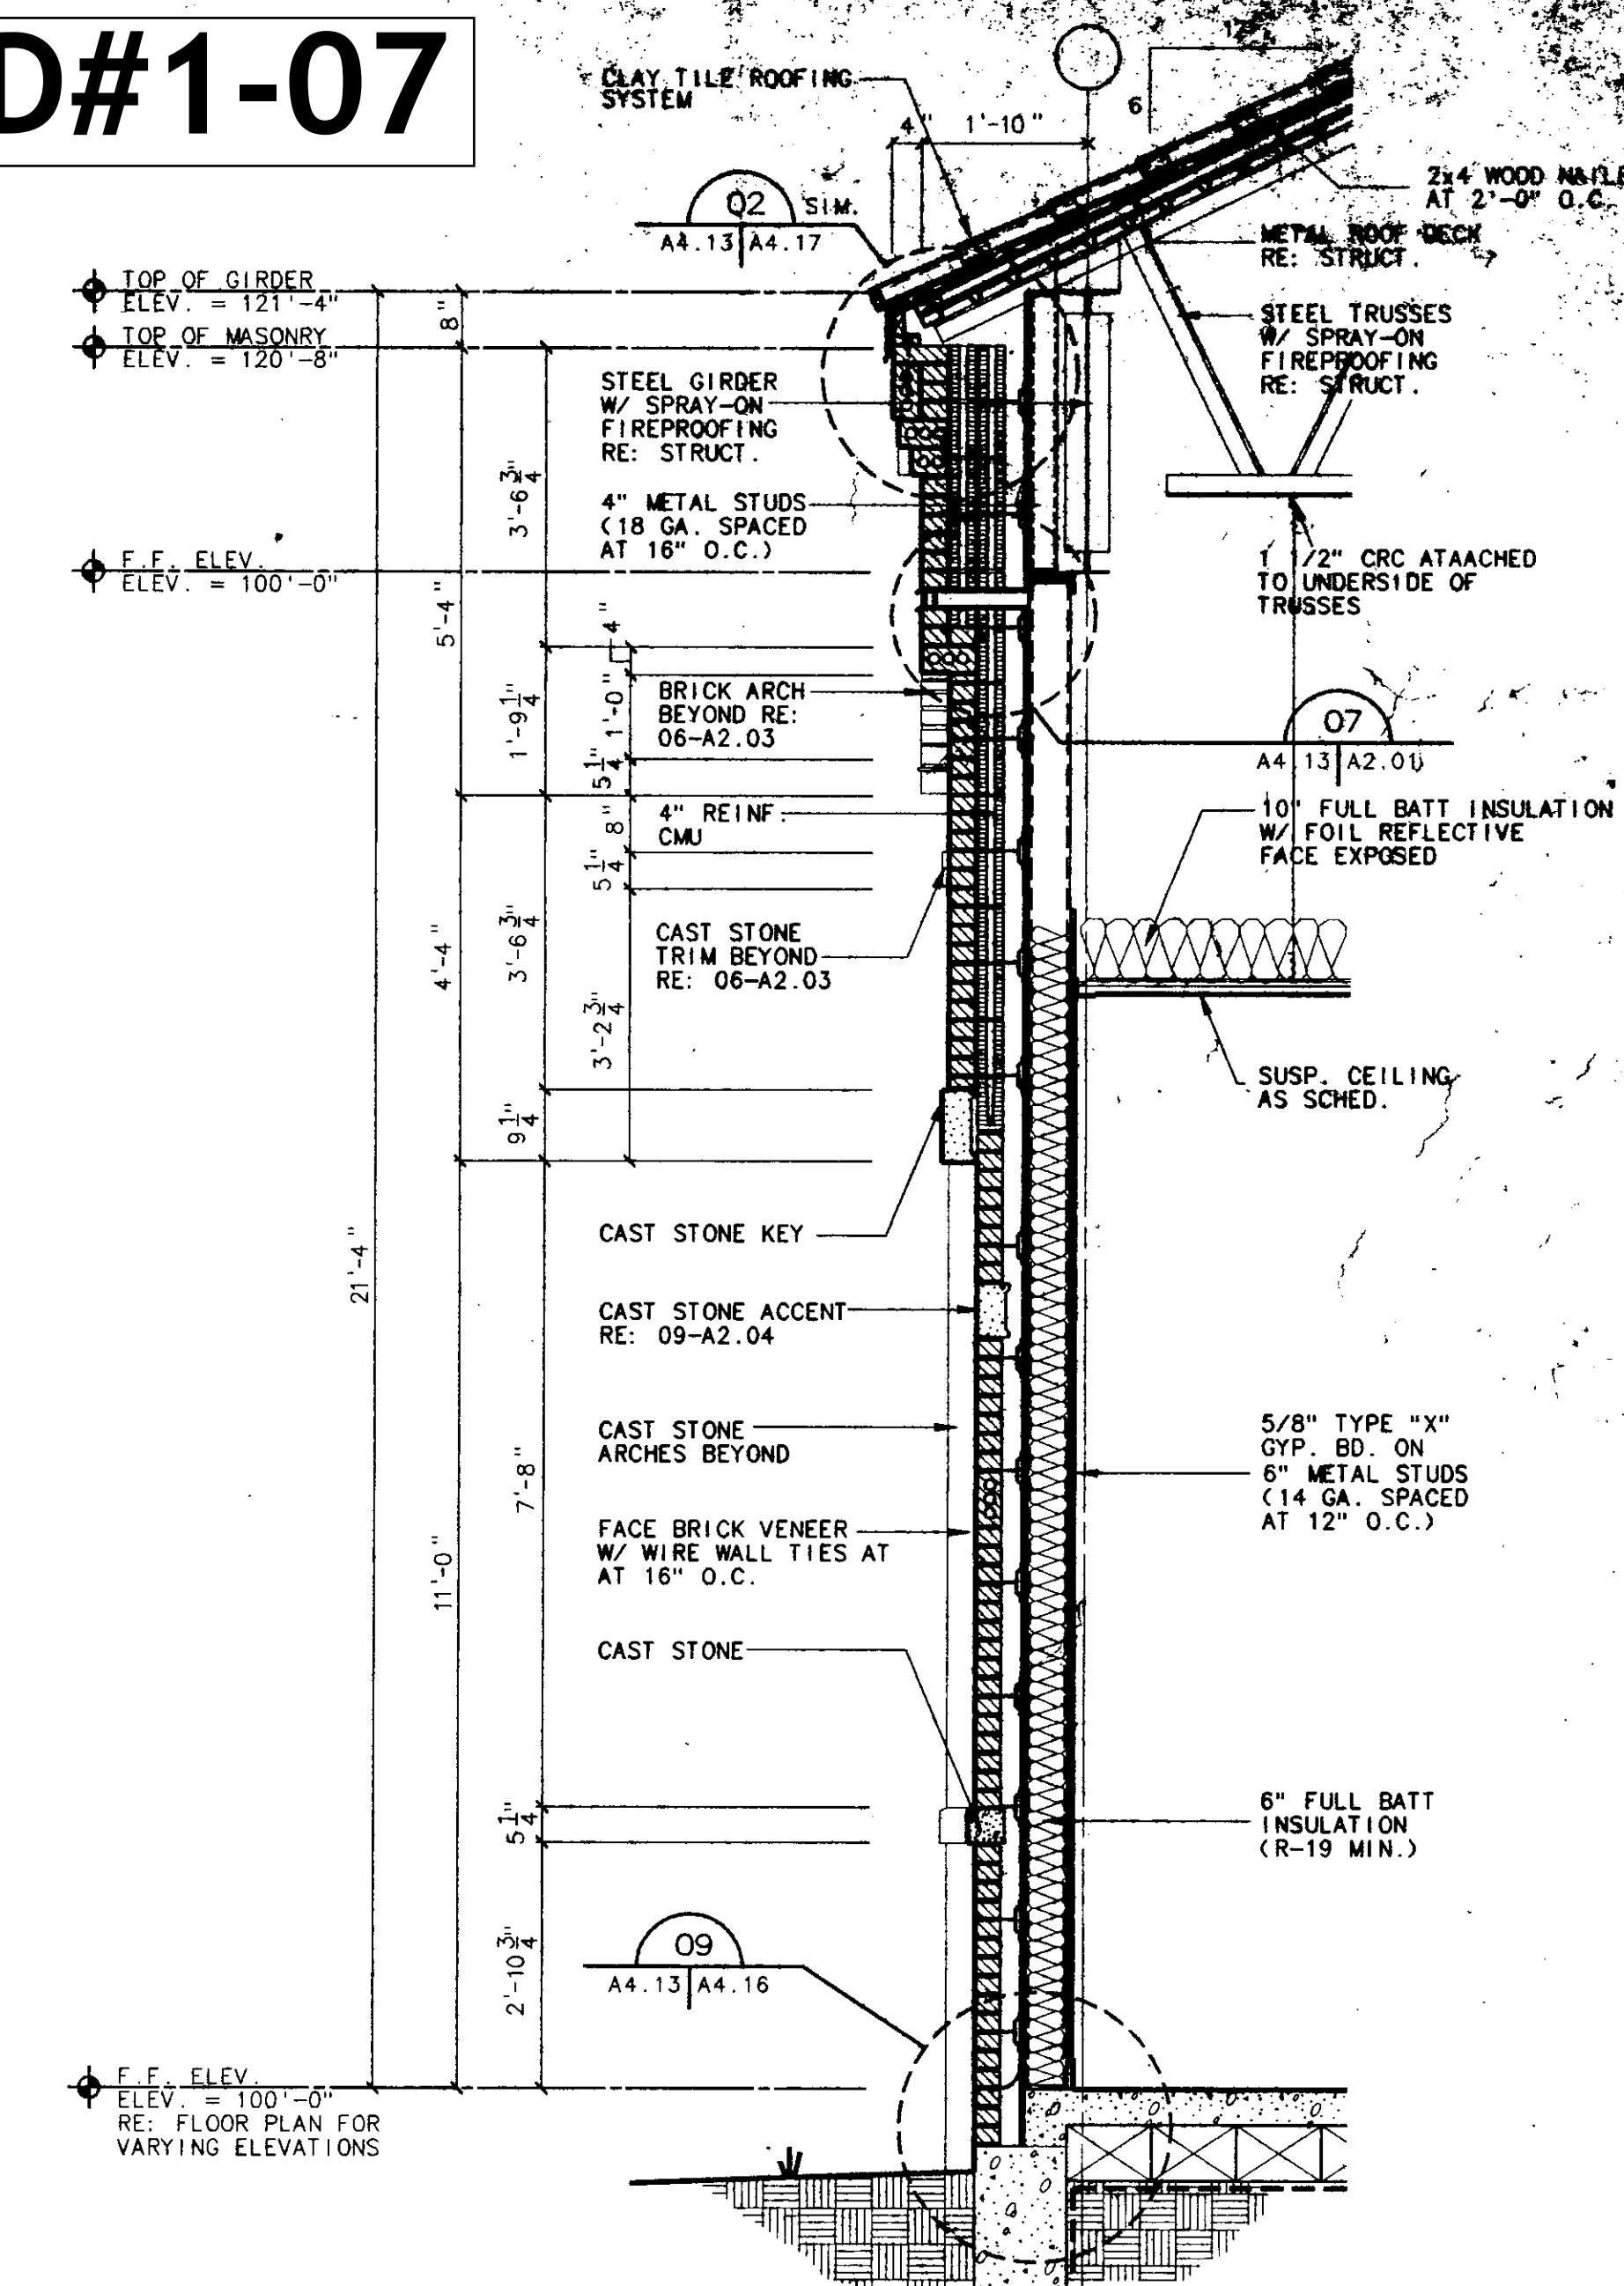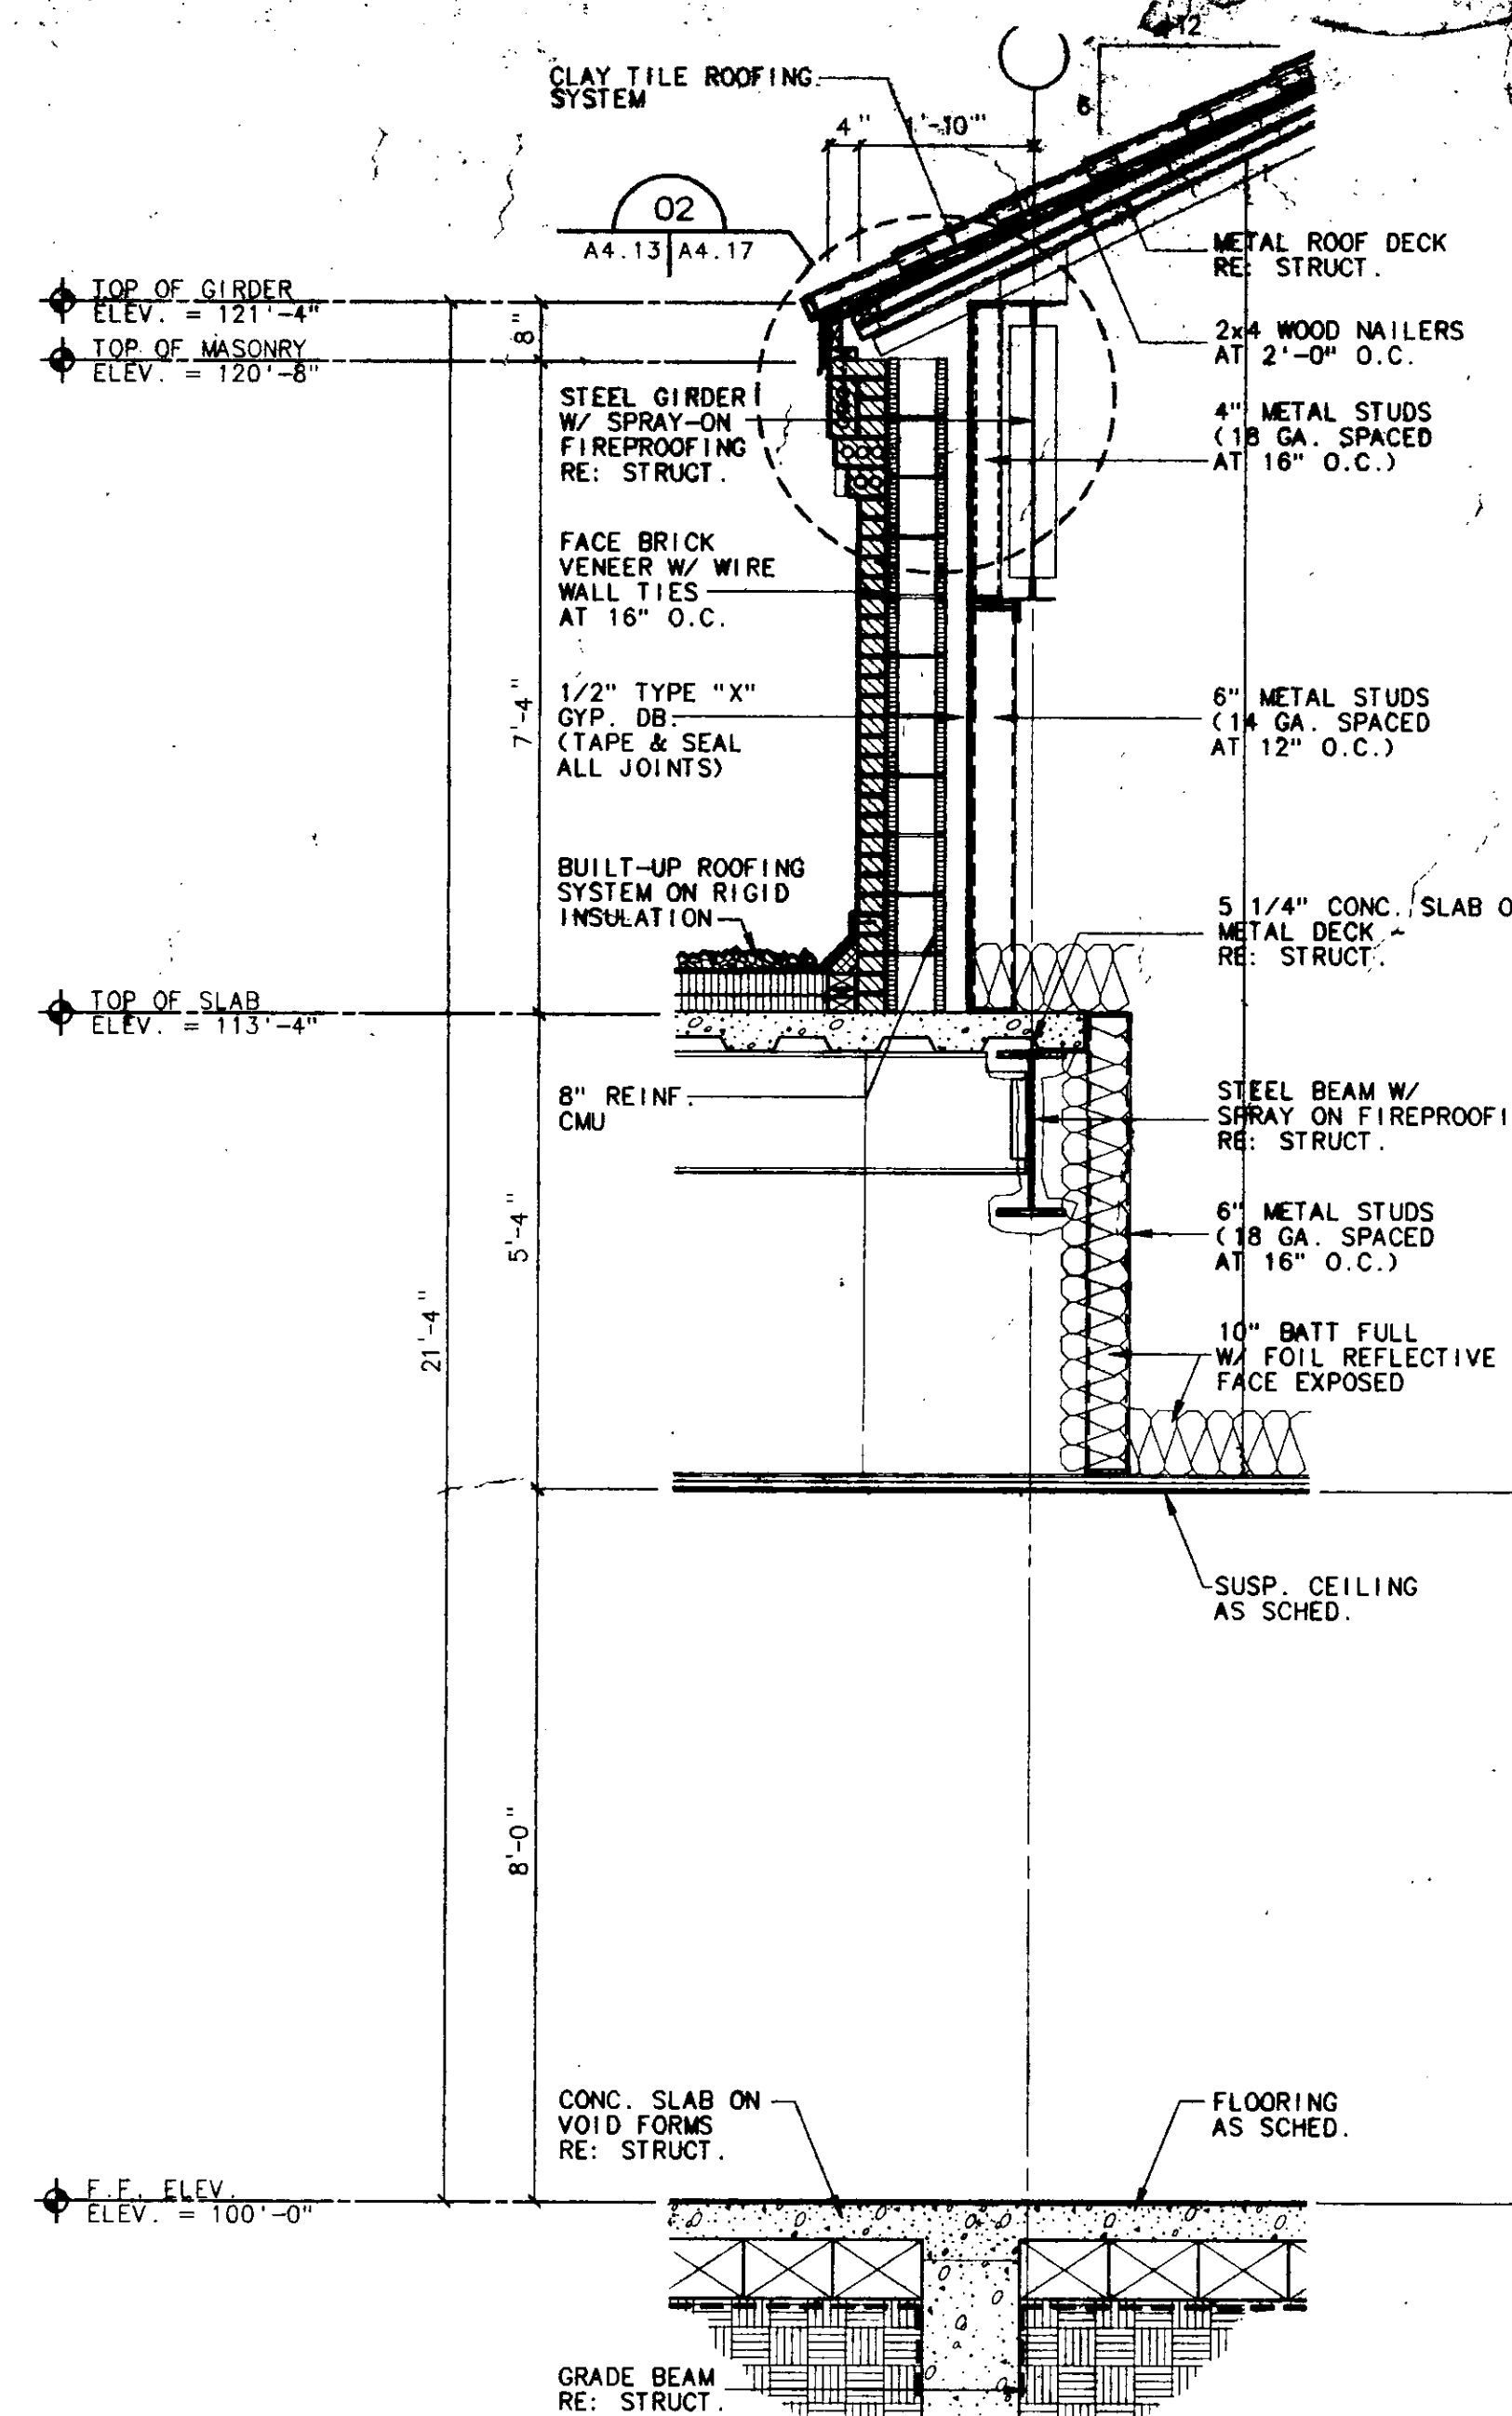


WALL SECTION AT LECTURE HALL (02)

WALL SECTION - TYP. LECTURE HALL (03)

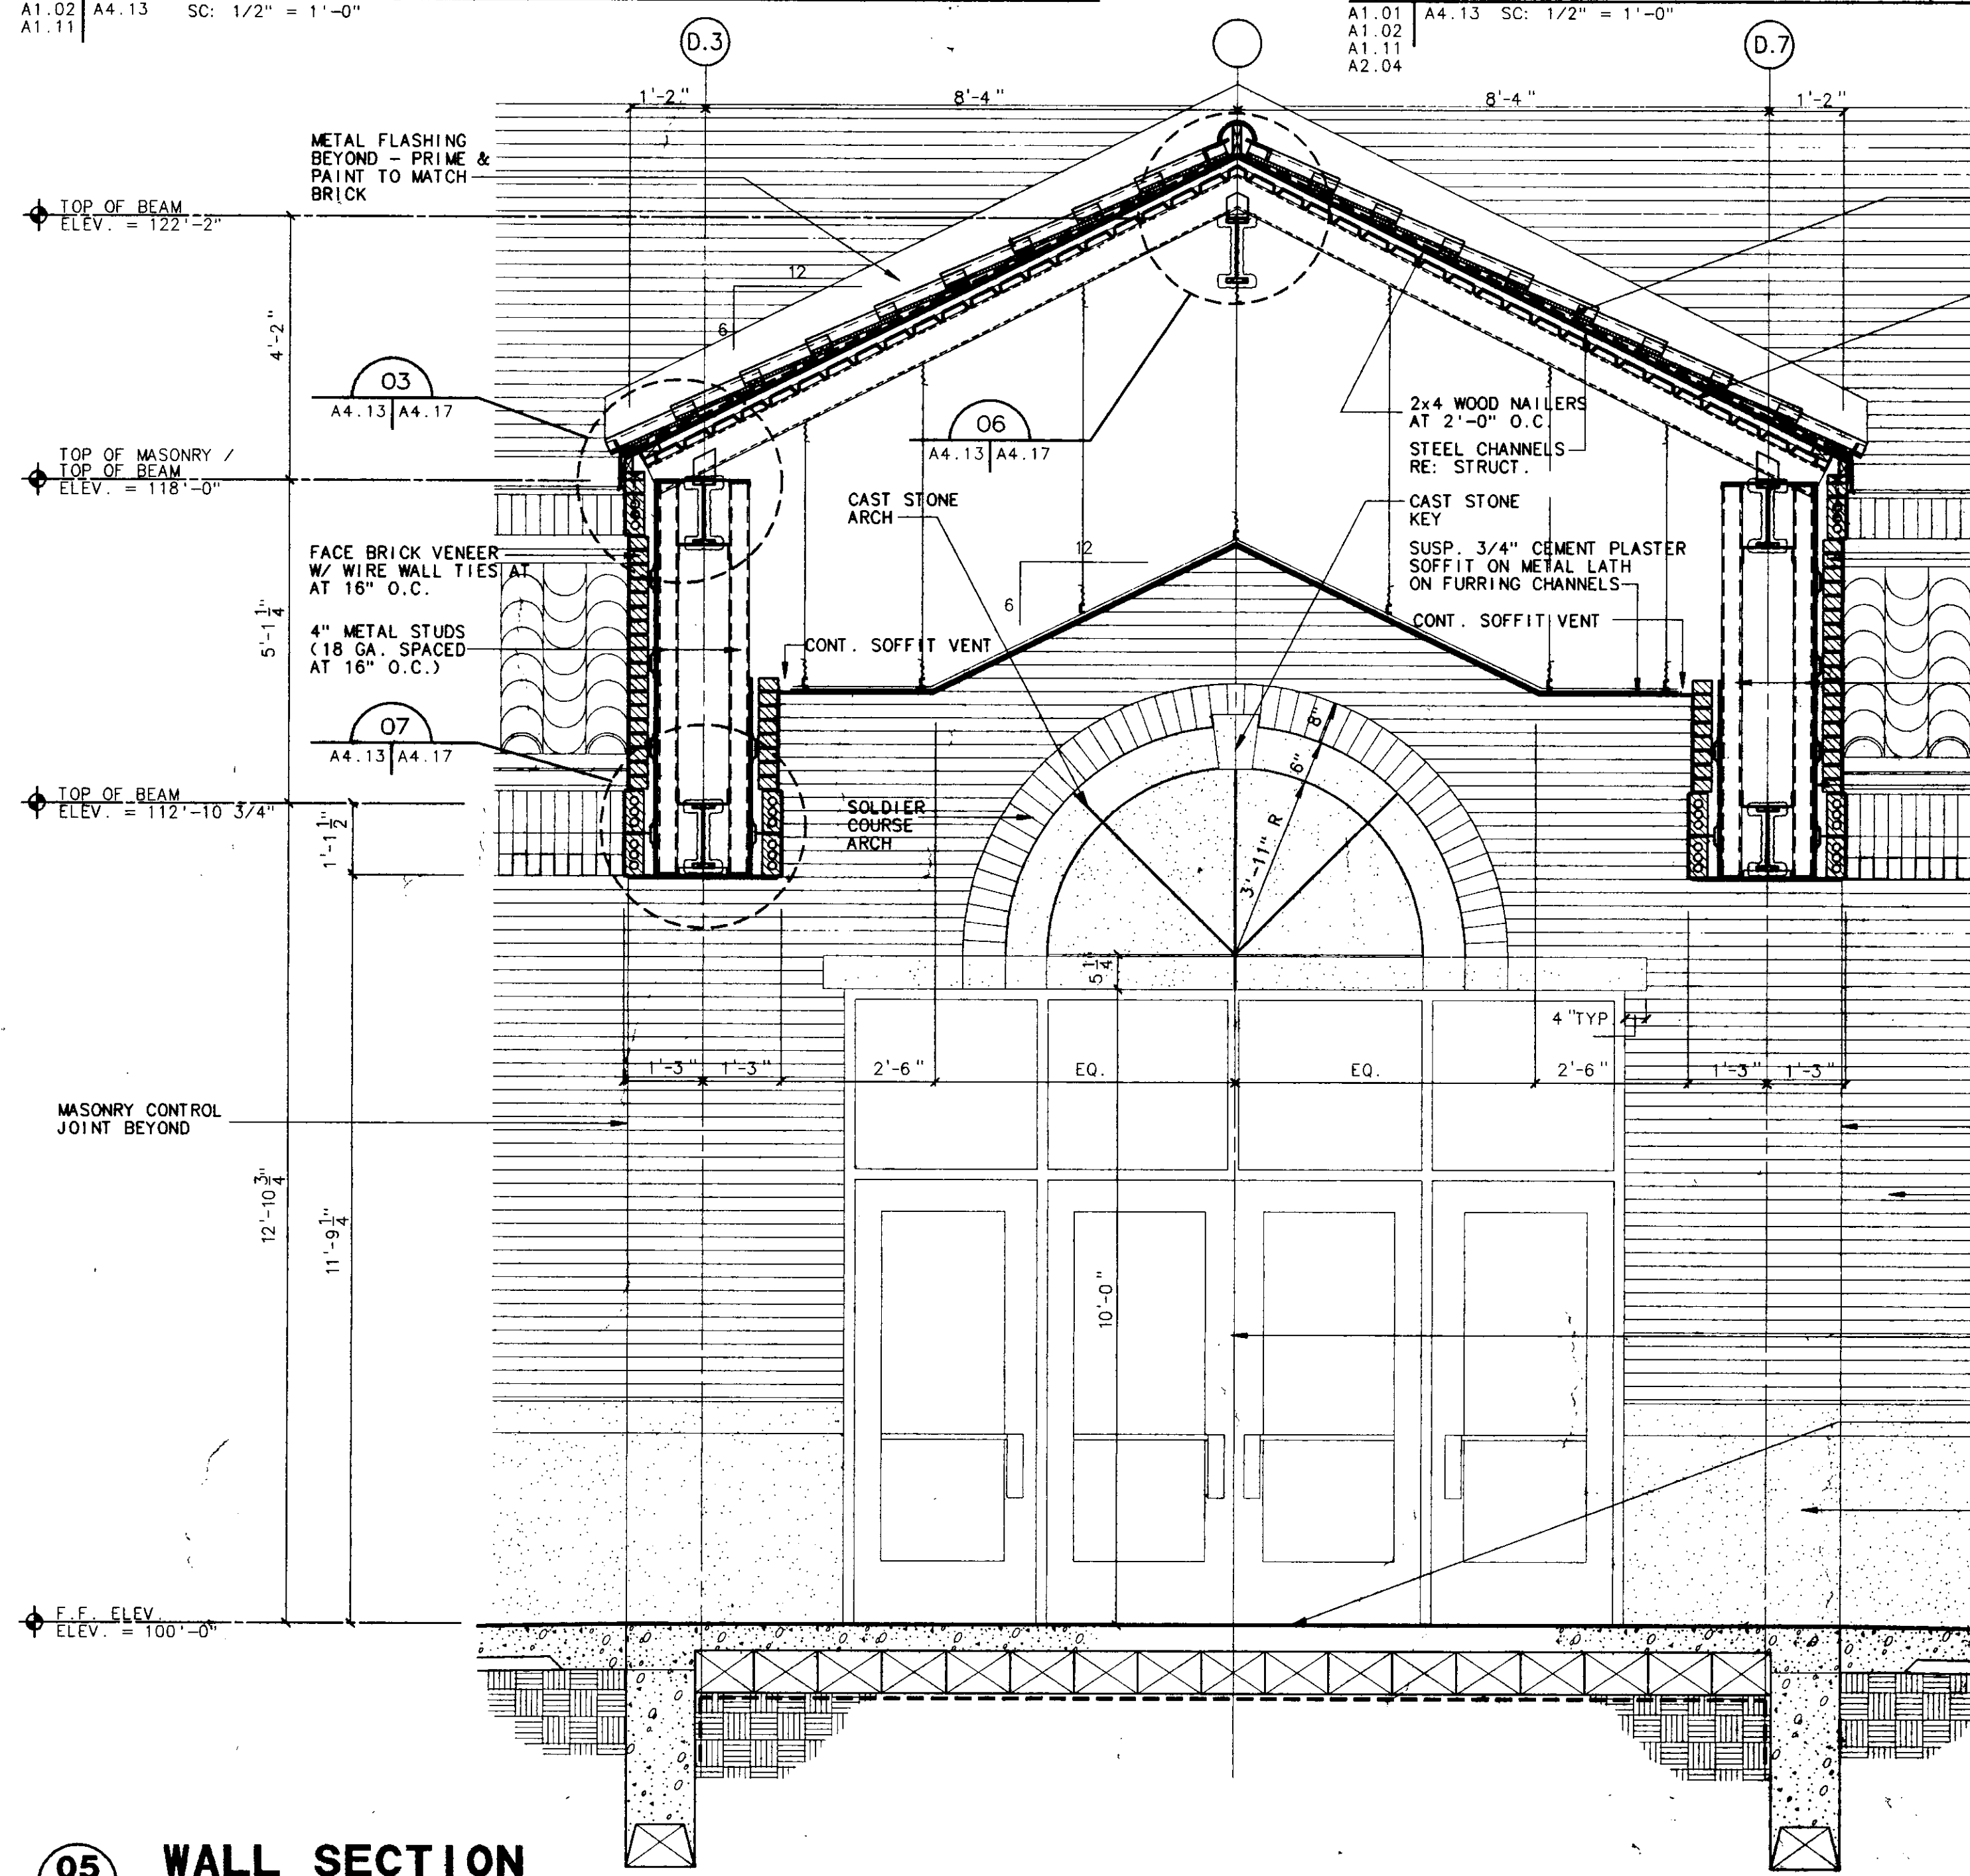

WALL SECTION (05)

NOT USED

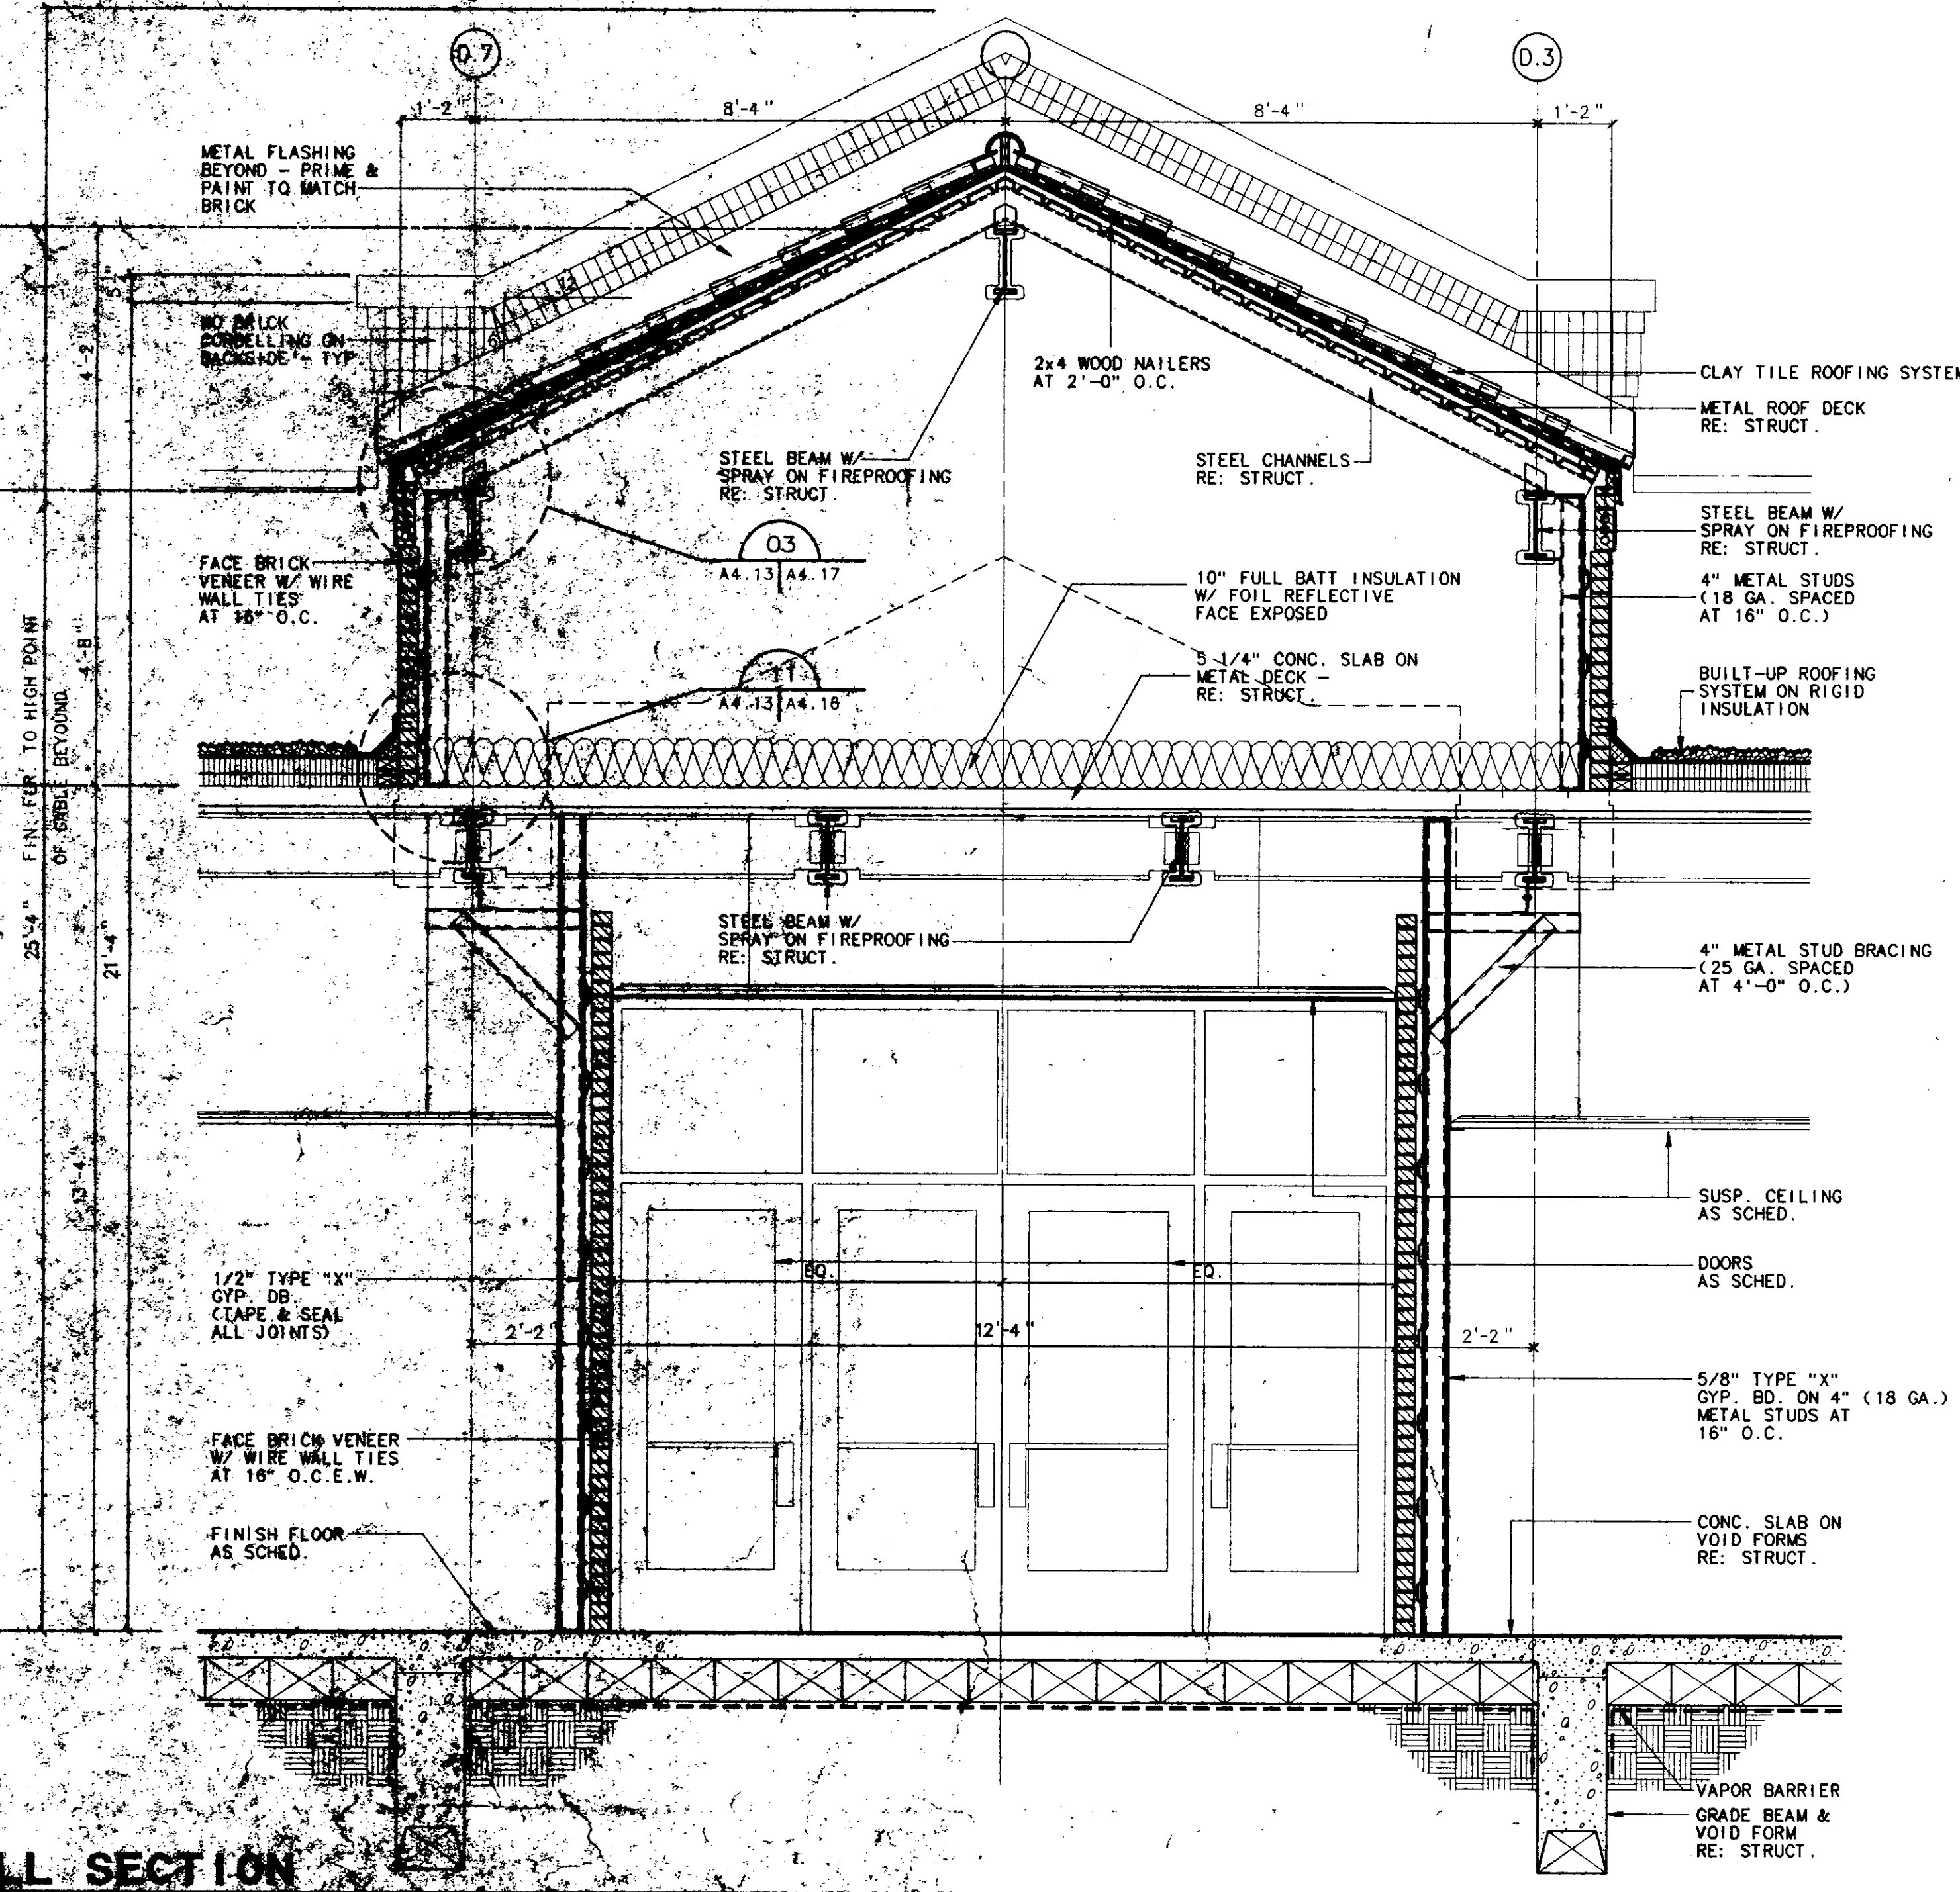


WALL SECTION (01)

J.S. BRIDWELL HALL
MIDWESTERN STATE UNIVERSITY
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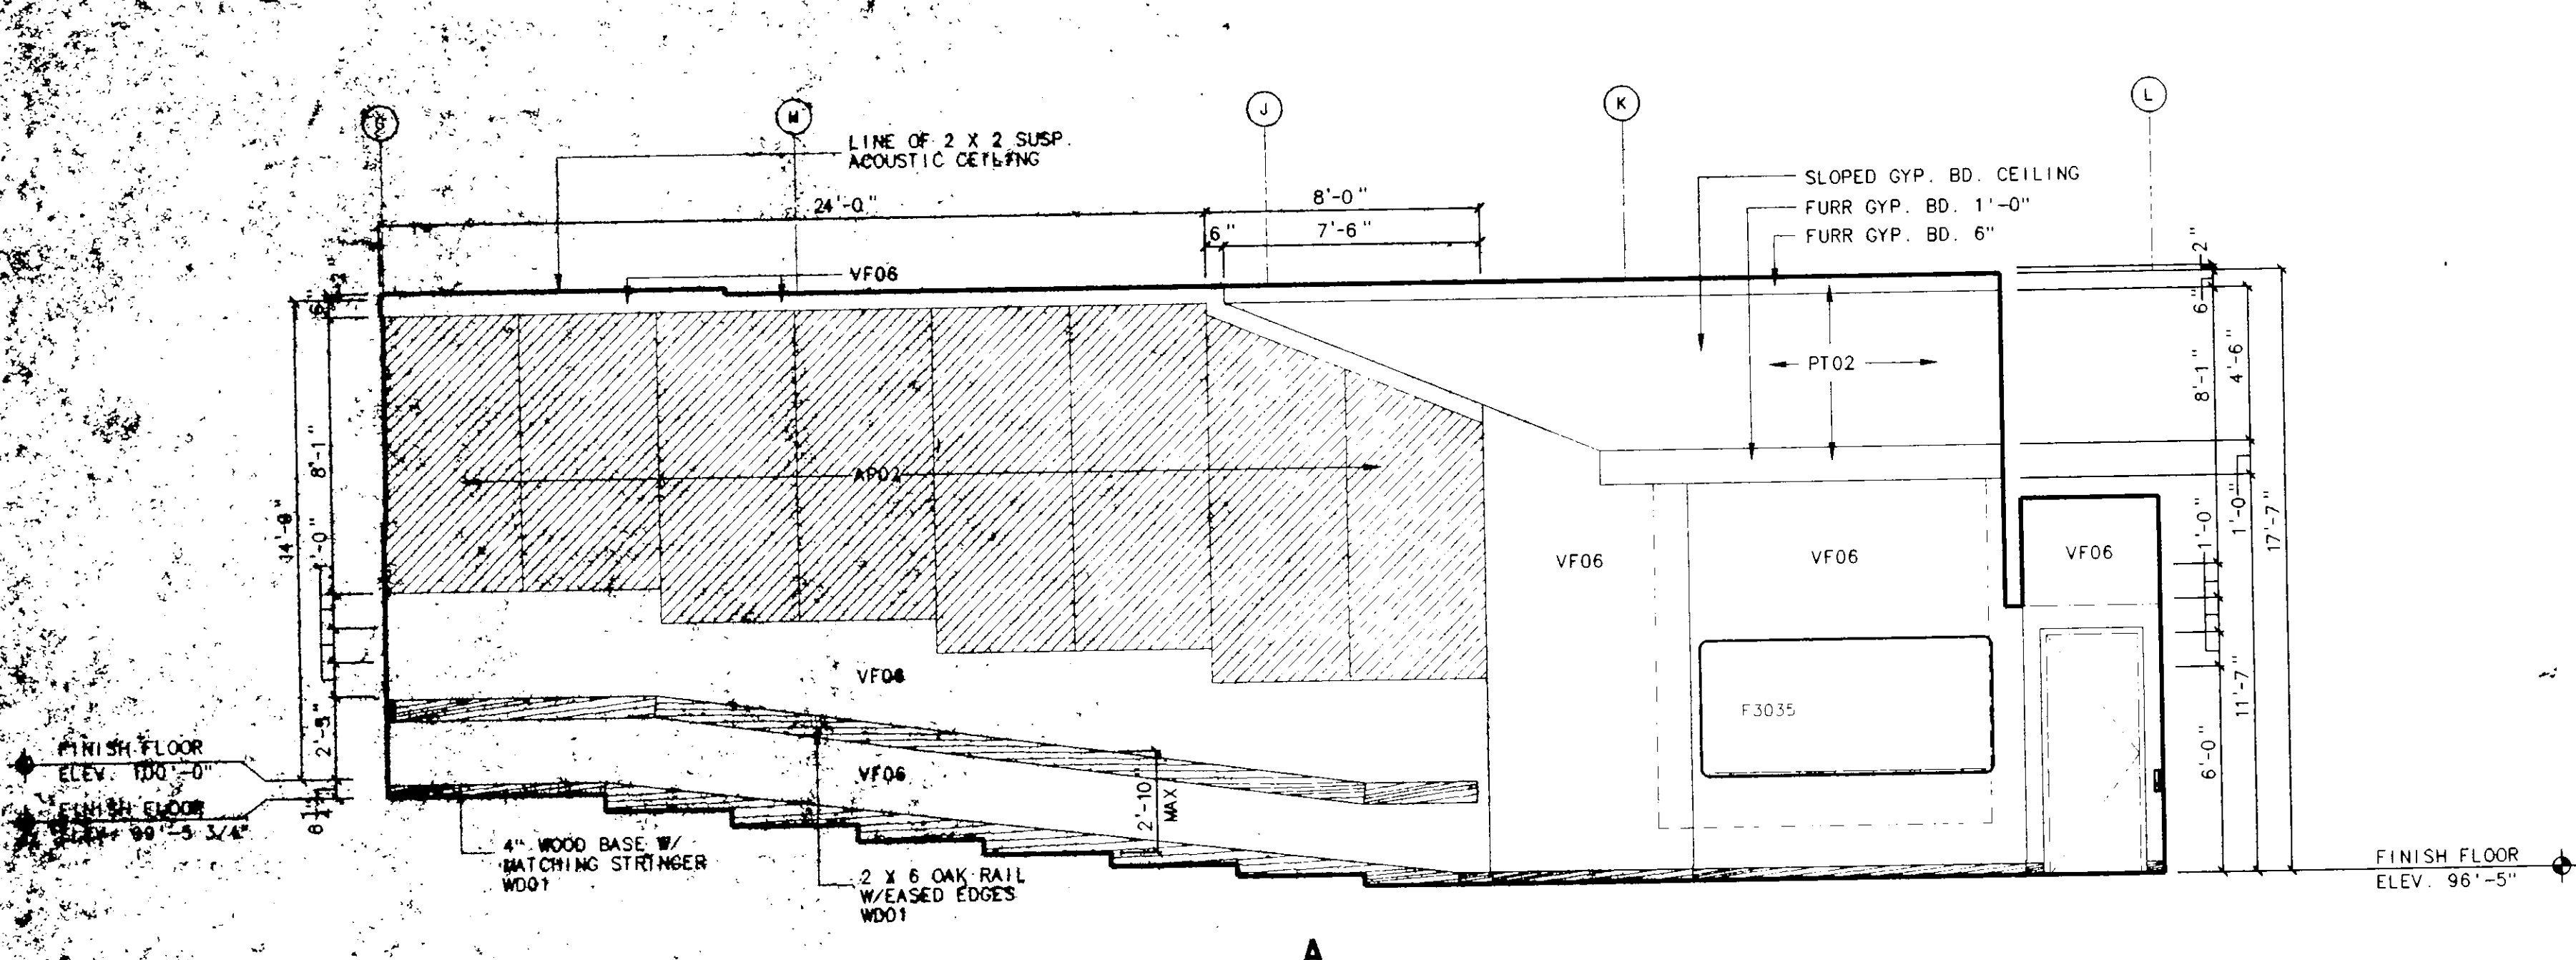
WINGLER & SHARP
ARCHITECTS & PLANNERS, INC.
WALL SECTIONS

JAN 3 1997
Sheet No. A4.13
5 of 12

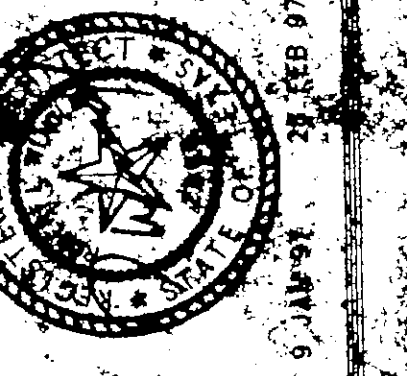


J.S. BRIDWELL HALL
MIDWESTERN STATE UNIVERSITY
WHITTA FALLS, TEXAS


WINGLER & SHARP
ARCHITECTS & PLANNERS, INC.
INTERIOR
ELEVATIONS




61 INTERIOR ELEVATION - LECTERN

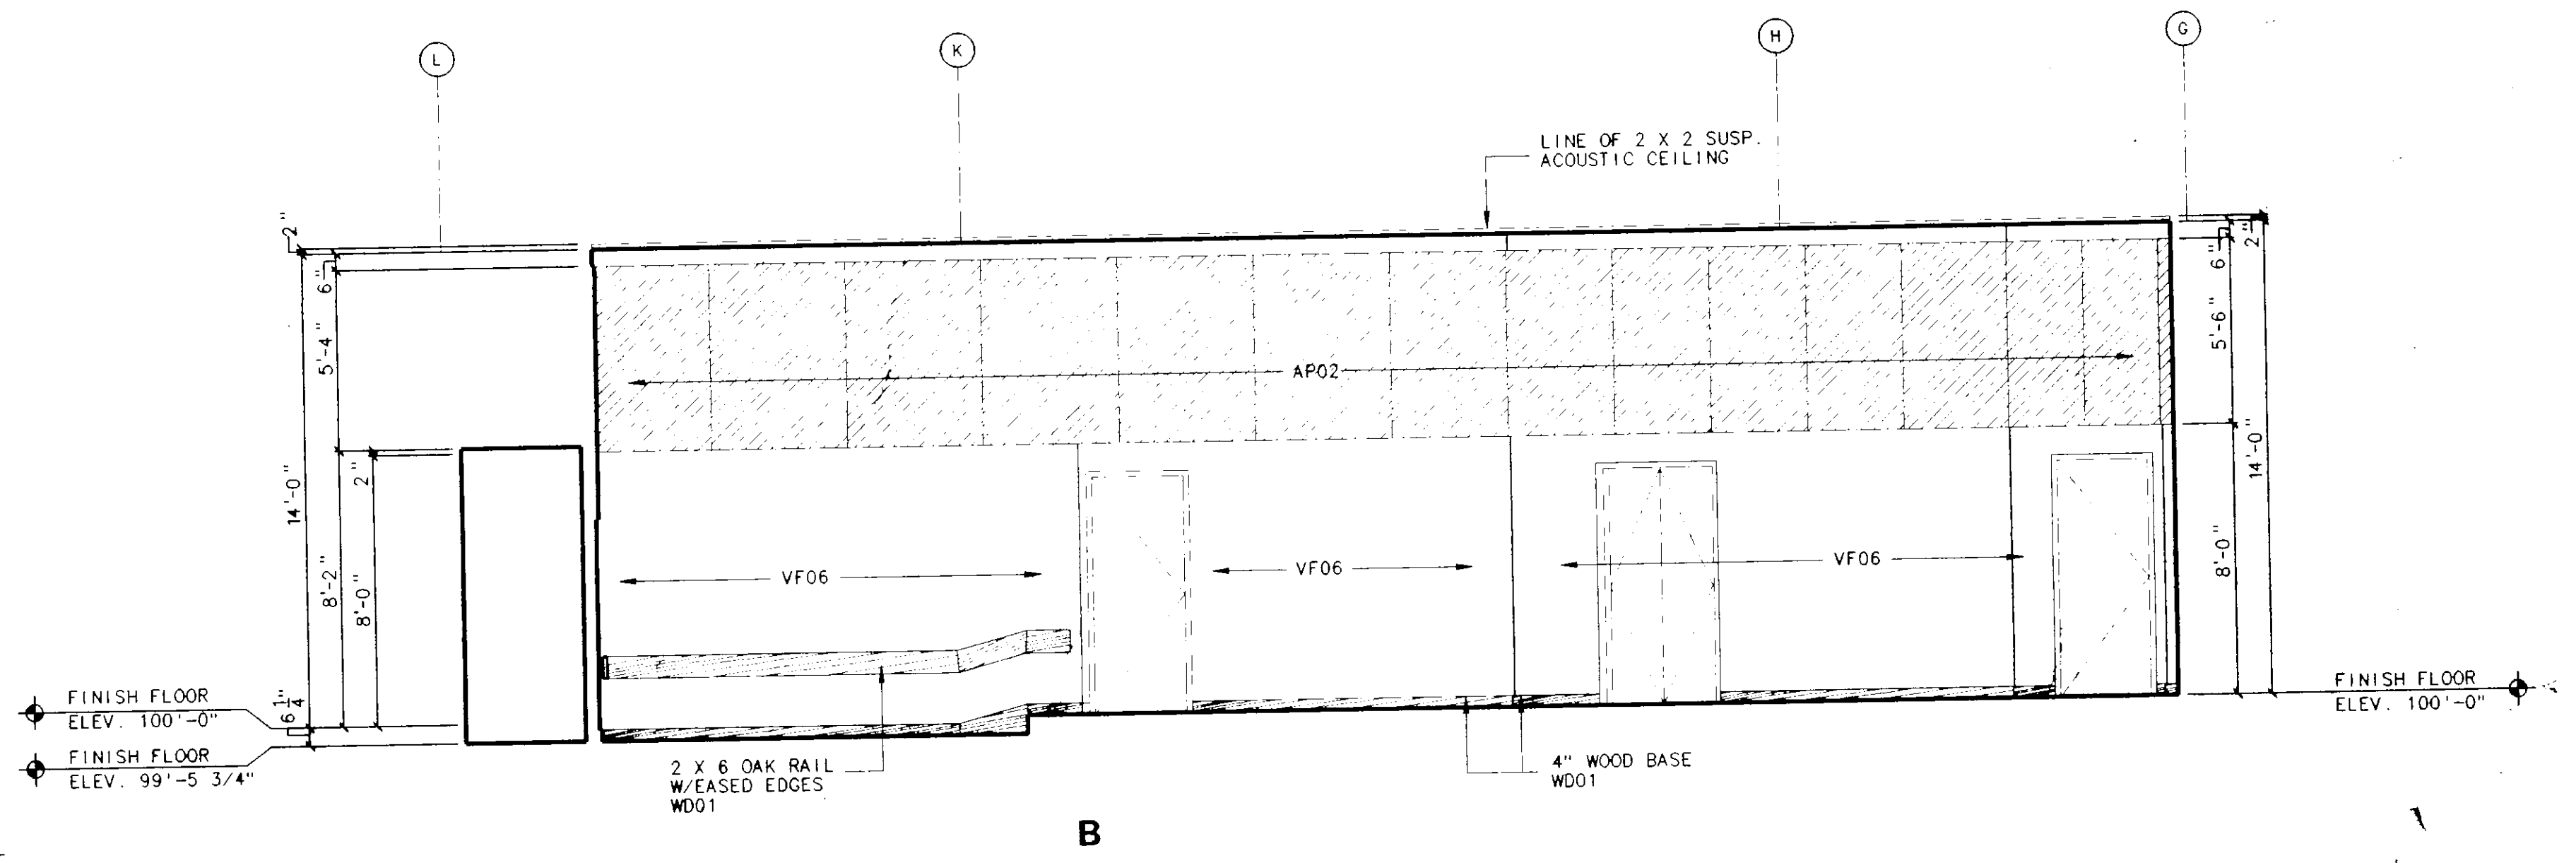

B

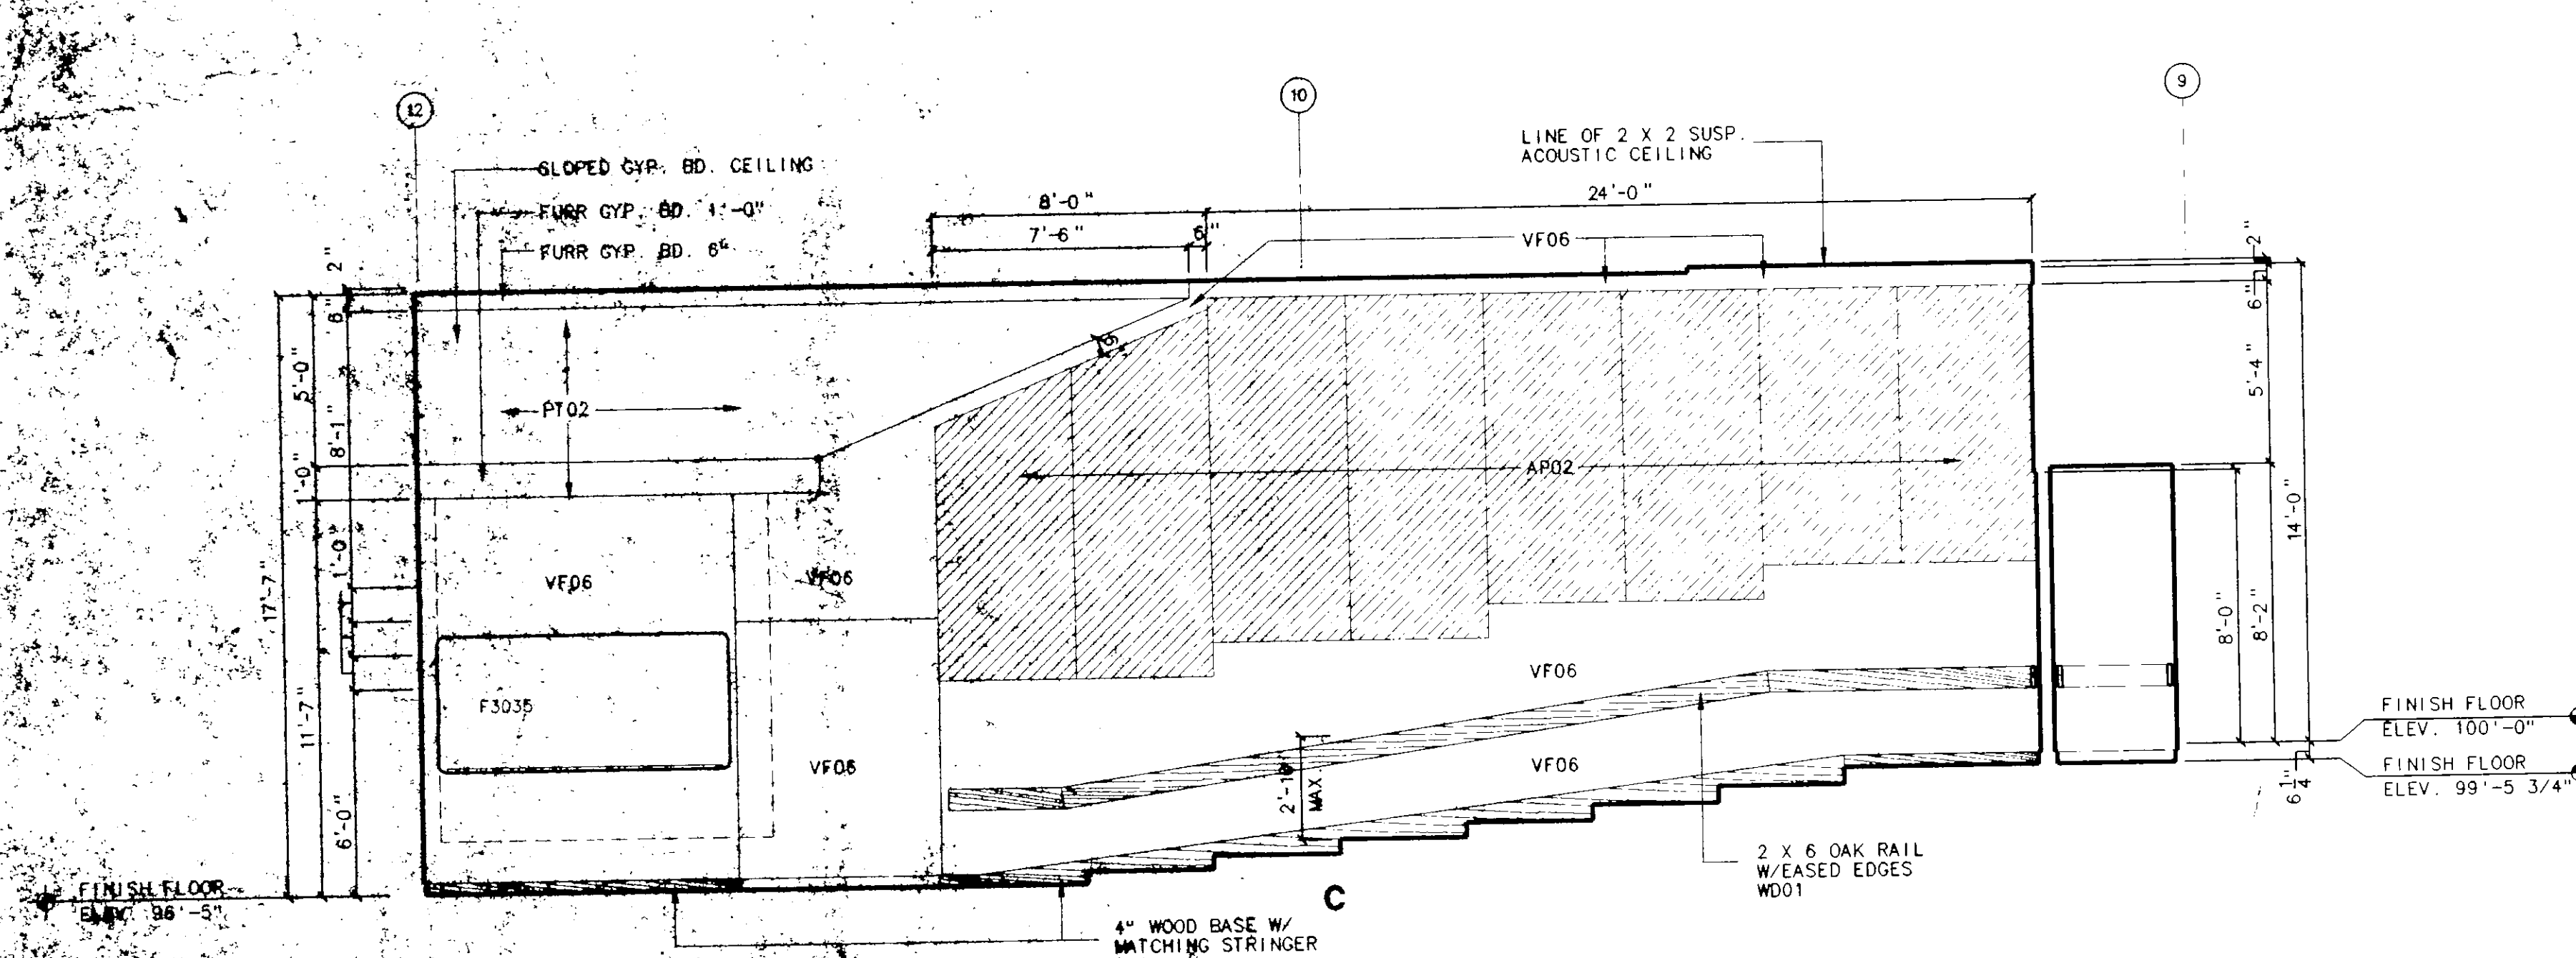

61 INTERIOR ELEVATION - LECTERN

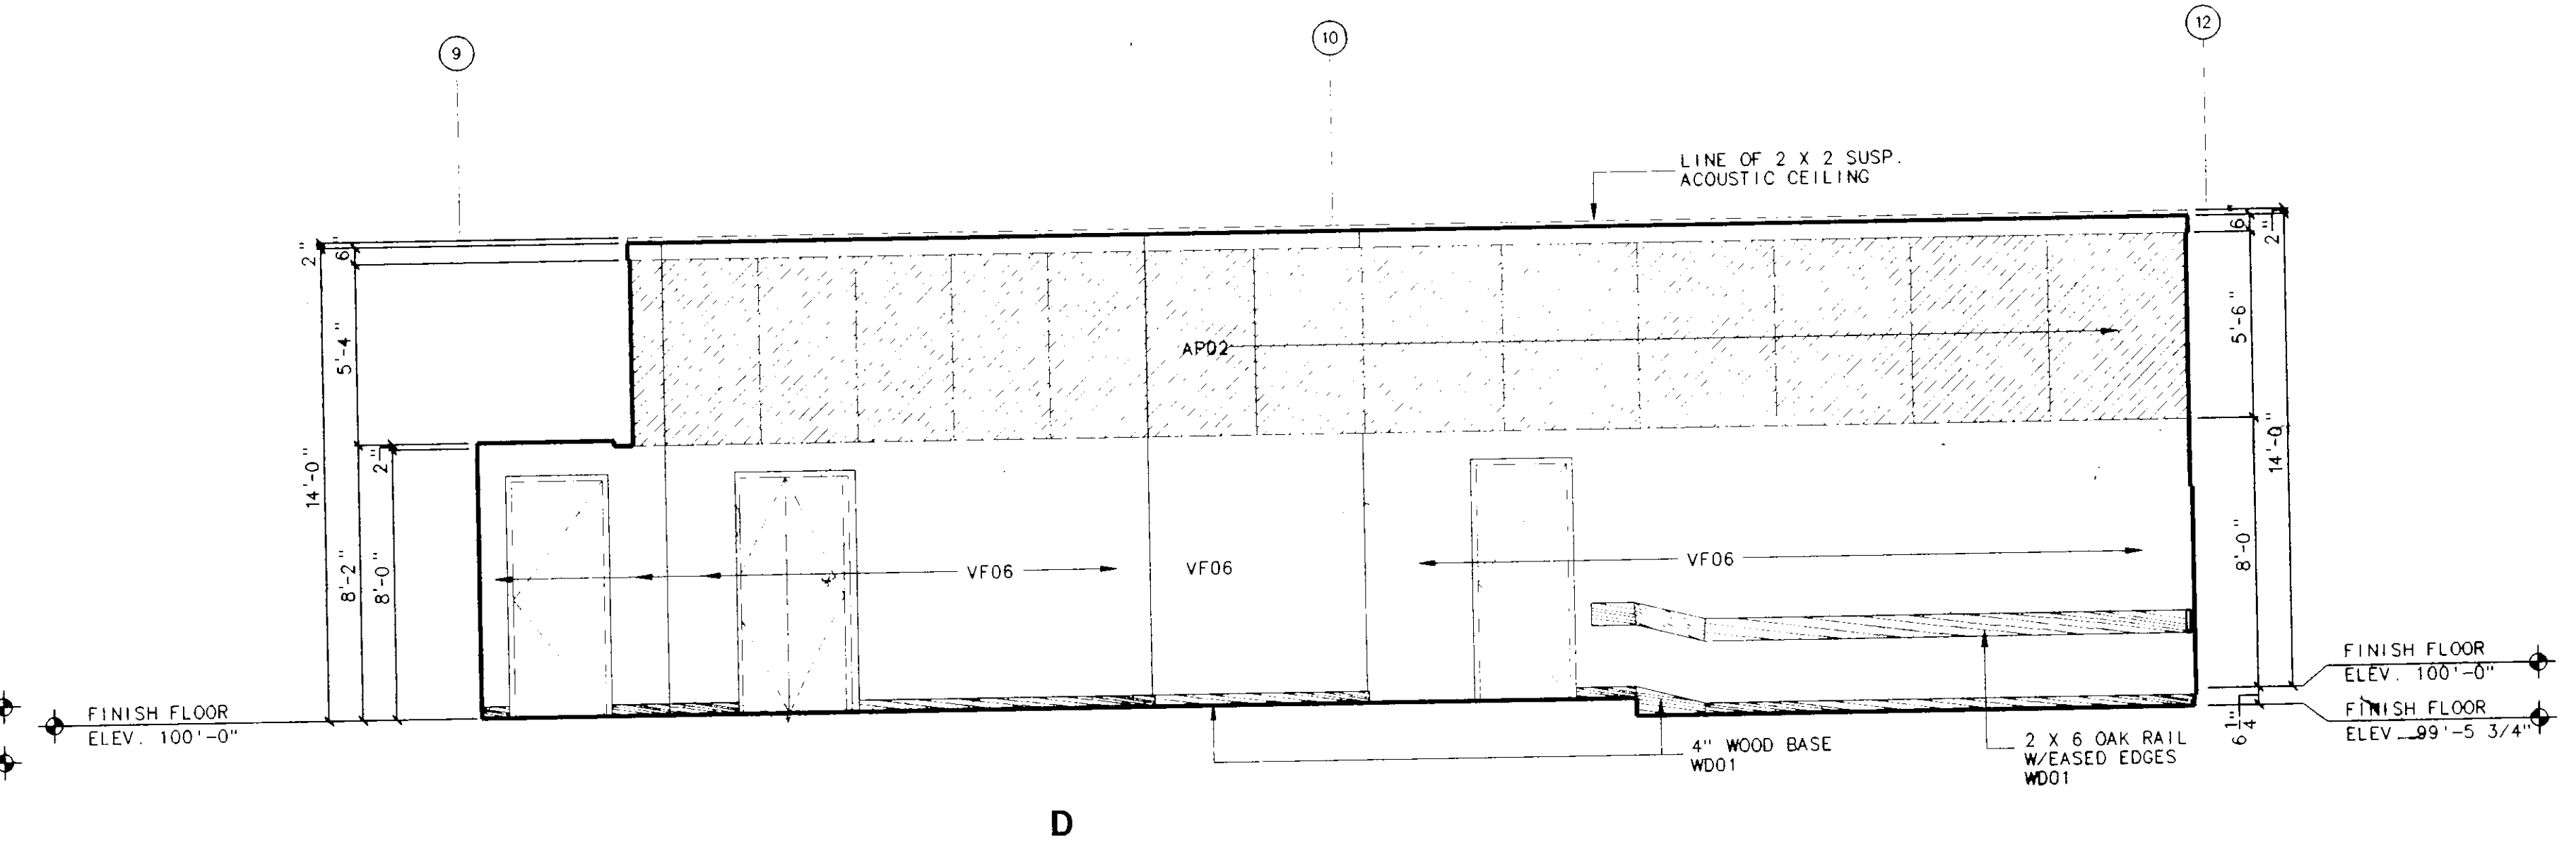

D